




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		SITE	SITE LIGHTING FIXTURE SCHEDULE	'n		
PE	DESCRIPTION	MANUF	CATALOG NUMBER	LAMPS	LAMPS VOLTAGE	REMARKS
>	בסיוב אסיוואדבה אדב ו העדואה בואדו ומב	LITHONIA	KAD-250M-R3-120-SPD-09-HS-SSA18-DM19	1 250W DOML	430	
A	FOLE MOUNTED SHE LIGHTING FIXTURE		OR PRE-APPROVED EQUAL		120	
		LITHONIA	KAD-250M-R3-120-SPD-09-SSA18-DM28AS			
SB	POLE MOUNTED SITE LIGHTING FIXTURE		OR PRE-APPROVED EQUAL	2-250W PSMH	120	
			and the second se			

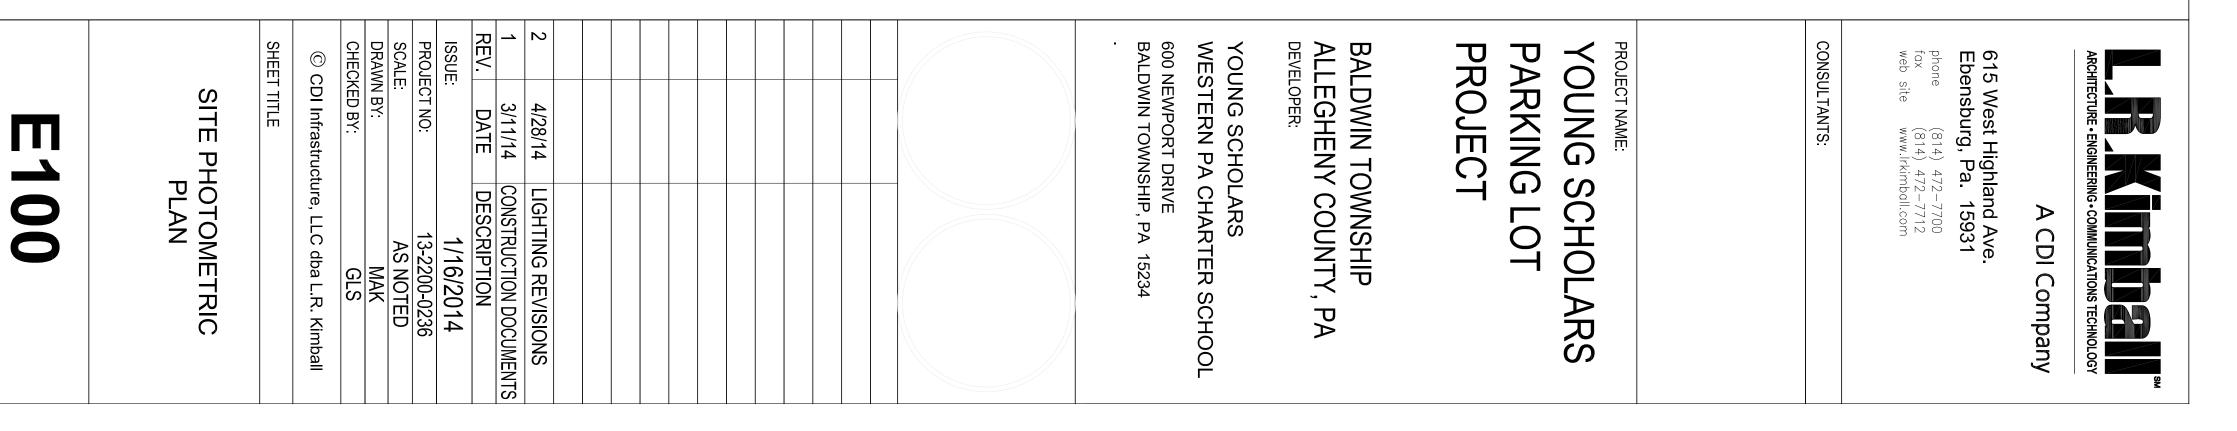

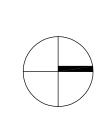





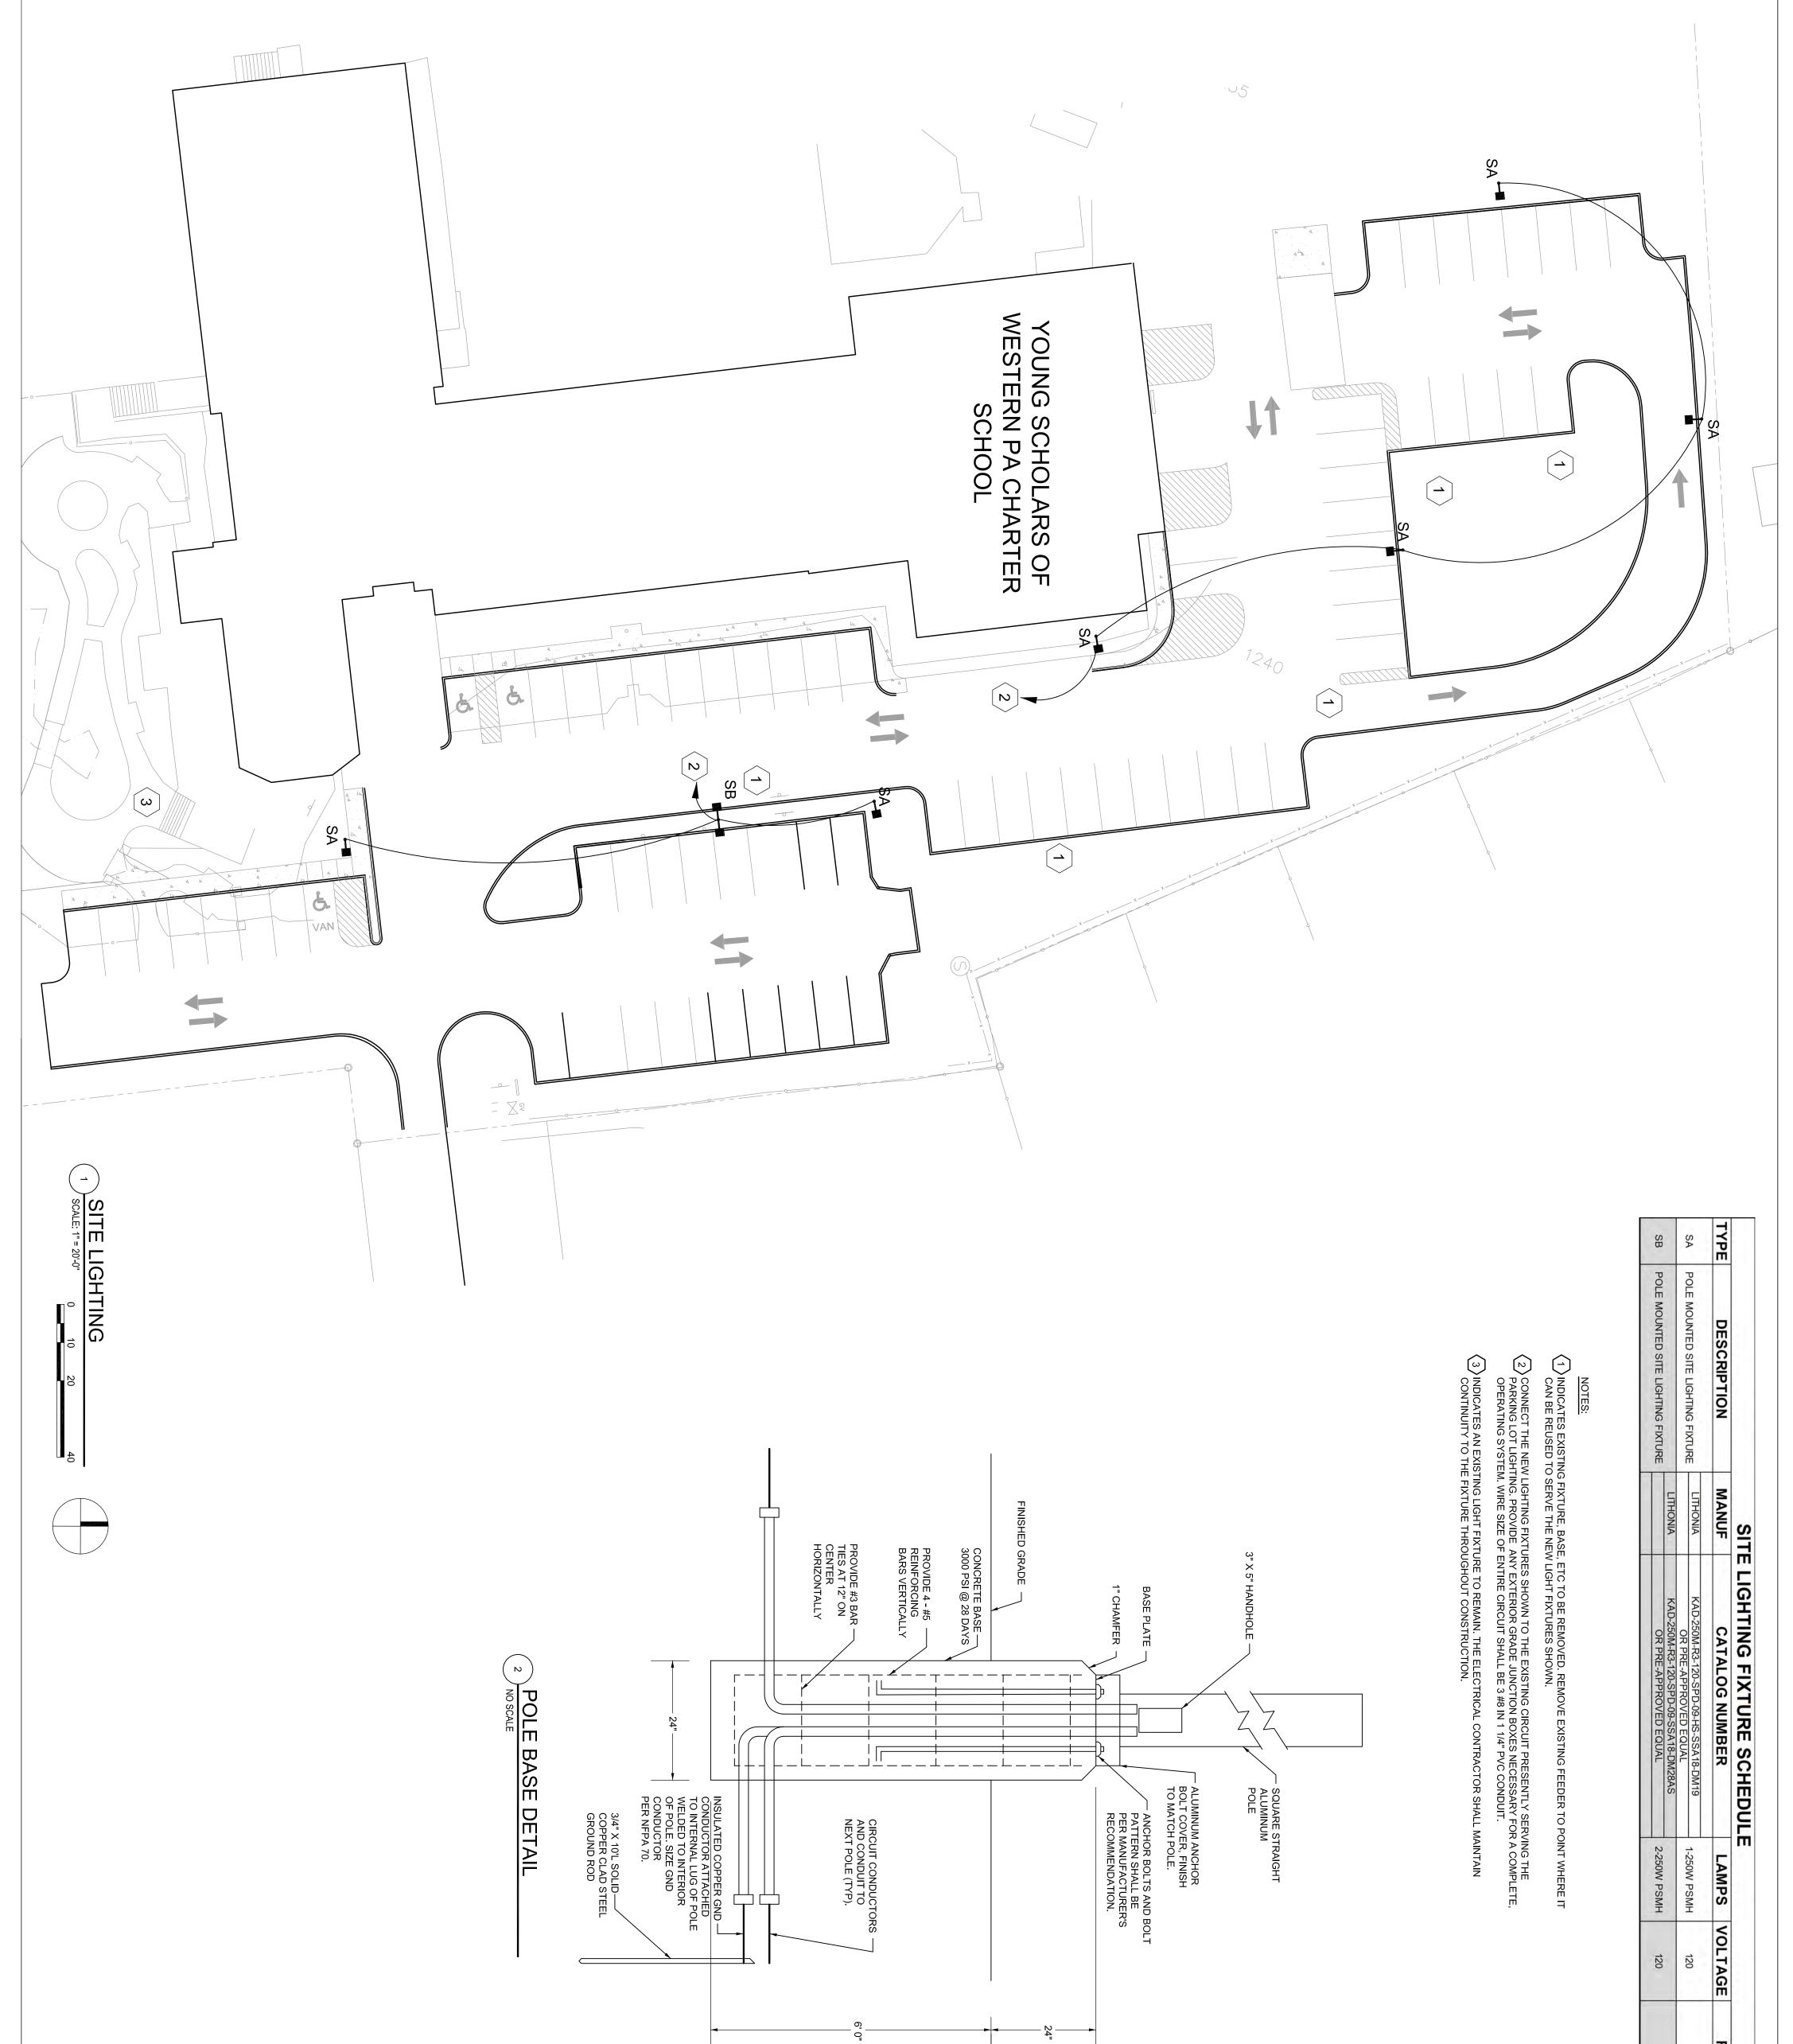JRE SCHEDULE	JLE		
UMBER	LAMPS	LAMPS VOLTAGE	REMARKS
9-HS-SSA18-DM19	1 DEDINI DENIL	400	
ED EQUAL		120	
9-SSA18-DM28AS			
ED EQUAL	2-250W PSMH	120	
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	I Infrastructure, LLC dt ITLE SITE LIGHTI PLAN	24/28/14LIGHTING REVISIONS13/11/14CONSTRUCTION DOCUMENTREV.DATEDESCRIPTIONISSUE:1/16/2014PROJECT NO:13-2200-0236SCALE:AS NOTEDDRAWN BY:MAK			BALDWIN TOWNSHIP ALLEGHENY COUNTY, PA Developer: YOUNG SCHOLARS WESTERN PA CHARTER SCHOOL 600 NEWPORT DRIVE BALDWIN TOWNSHIP, PA 15234	PROJECT NAME: YOUNG SCHOLARS PARKING LOT PROJECT	615 West Highland Ave. bone (814) 472–7700 fax (814) 472–7712 www.Irkimball.com CONSULTANTS:	ARCHITECTURE • ENGINEERING • COMMUNICATIONS TECHNOLOGY
--	---	--	--	--	--	---	--	--



LEGEND:

——1230— — —

TREE/SHRUB

TREE/SHRUB LINE

INTERMEDIATE CONTOUR

INDEX CONTOUR

SURVEY COMPLETED ON OCT 23, & NOV. 19, 2013 HORIZ. DATUM PA STATE PLANE SOUTH NAD 83 VERT. DATUM NAVD 88



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CONSULTANTS:

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YOUNG SCHOLARS PARKING LOT PROJECT


BALDWIN TOWNSHIP ALLEGHENY COUNTY, PA DEVELOPER:

YOUNG SCHOLARS WESTERN PA CHARTER SCHOOL

600 NEWPORT DRIVE BALDWIN TOWNSHIP, PA 15234

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1	3/10/14	CONSTRUCTION DOCUMENTS		
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$^{\odot}$ CDI Infrastructure, LLC dba L.R. Kimball				
SHEET TITLE				
EXISTING CONDITIONS PLAN				
	C (000		

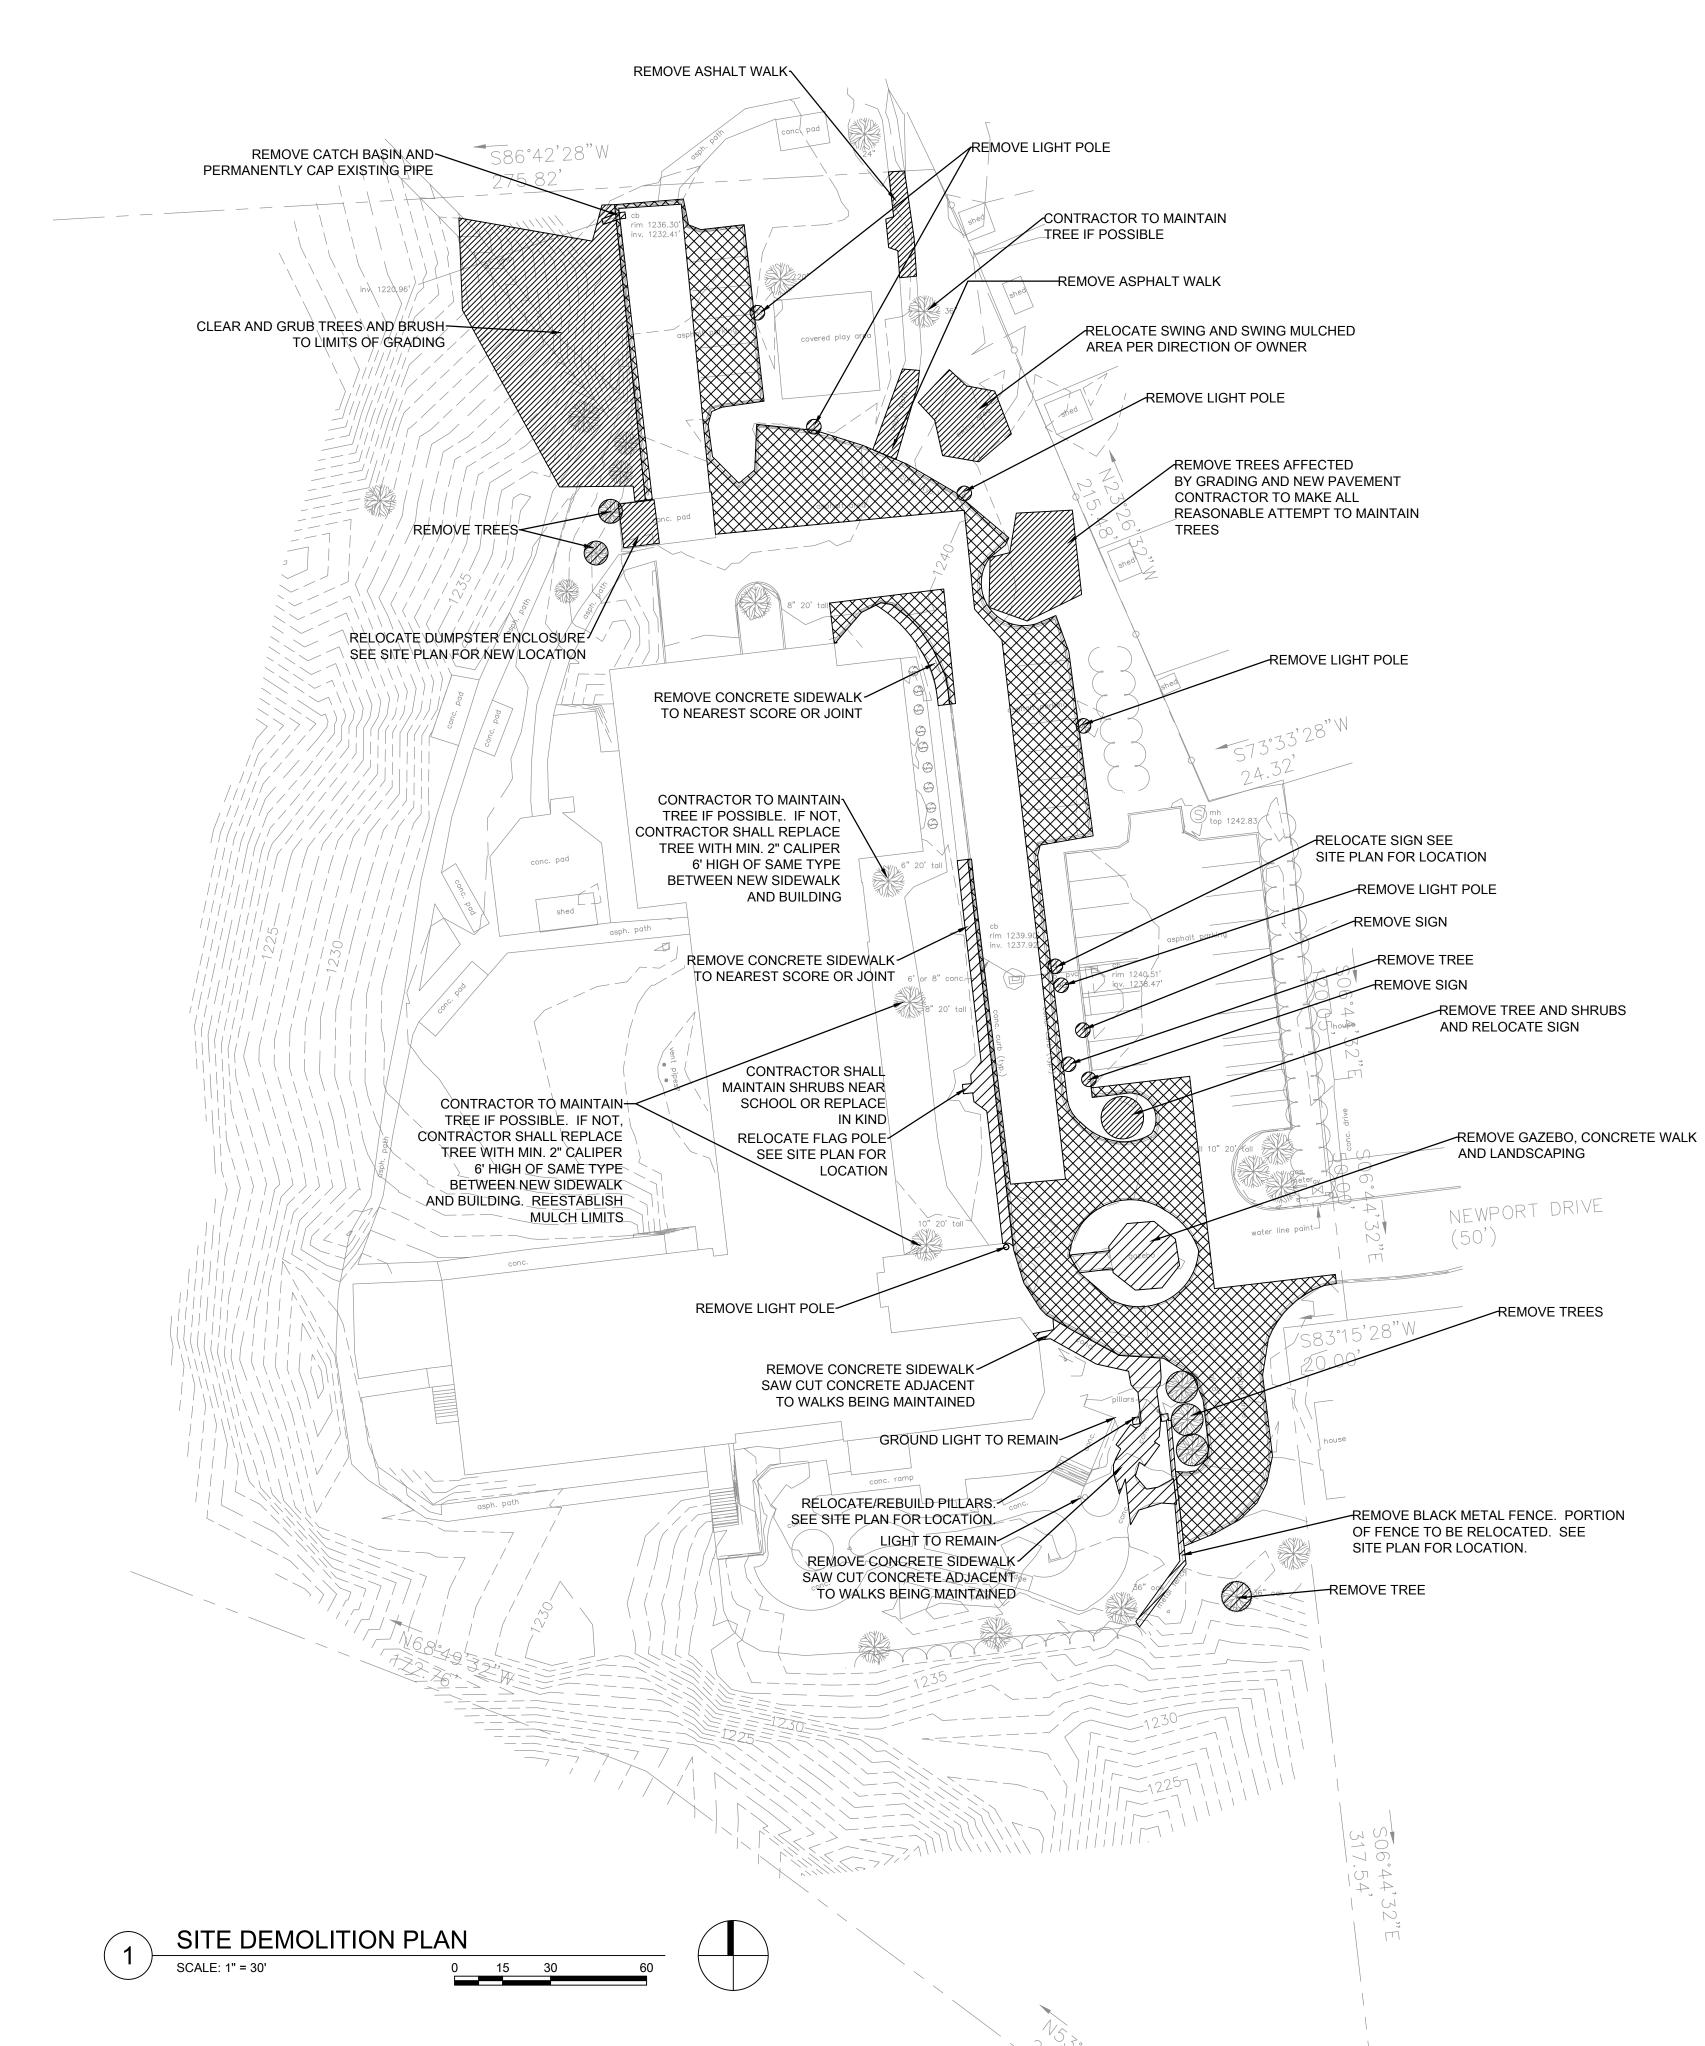

DEMOLITION PLAN NOTES:

- 1. Refer to Electrical Drawings for exterior site lighting demolition and new pole locations.
- 2. No material shall be stored or piled with 25'-0" of the trunks of any tree to remain.
- 3. The limits of site demolition shown on this plan are approximate. Contractor shall verify all existing conditions, prior to proceeding with work, and adjust the limits as necessary to complete the required work.
- 4. Contractor shall make every reasonable effort to save trees located close to the proposed work.
- 5. Contractor shall remove items in their entirety, including underground features. 6. See Site Plan for additional items to be removed.

DEMOLITION PLAN LEGEND:

PAVEMENT AND CURB TO BE REMOVED

ITEM TO BE REMOVED REFER TO PLAN FOR DESCRIPTION



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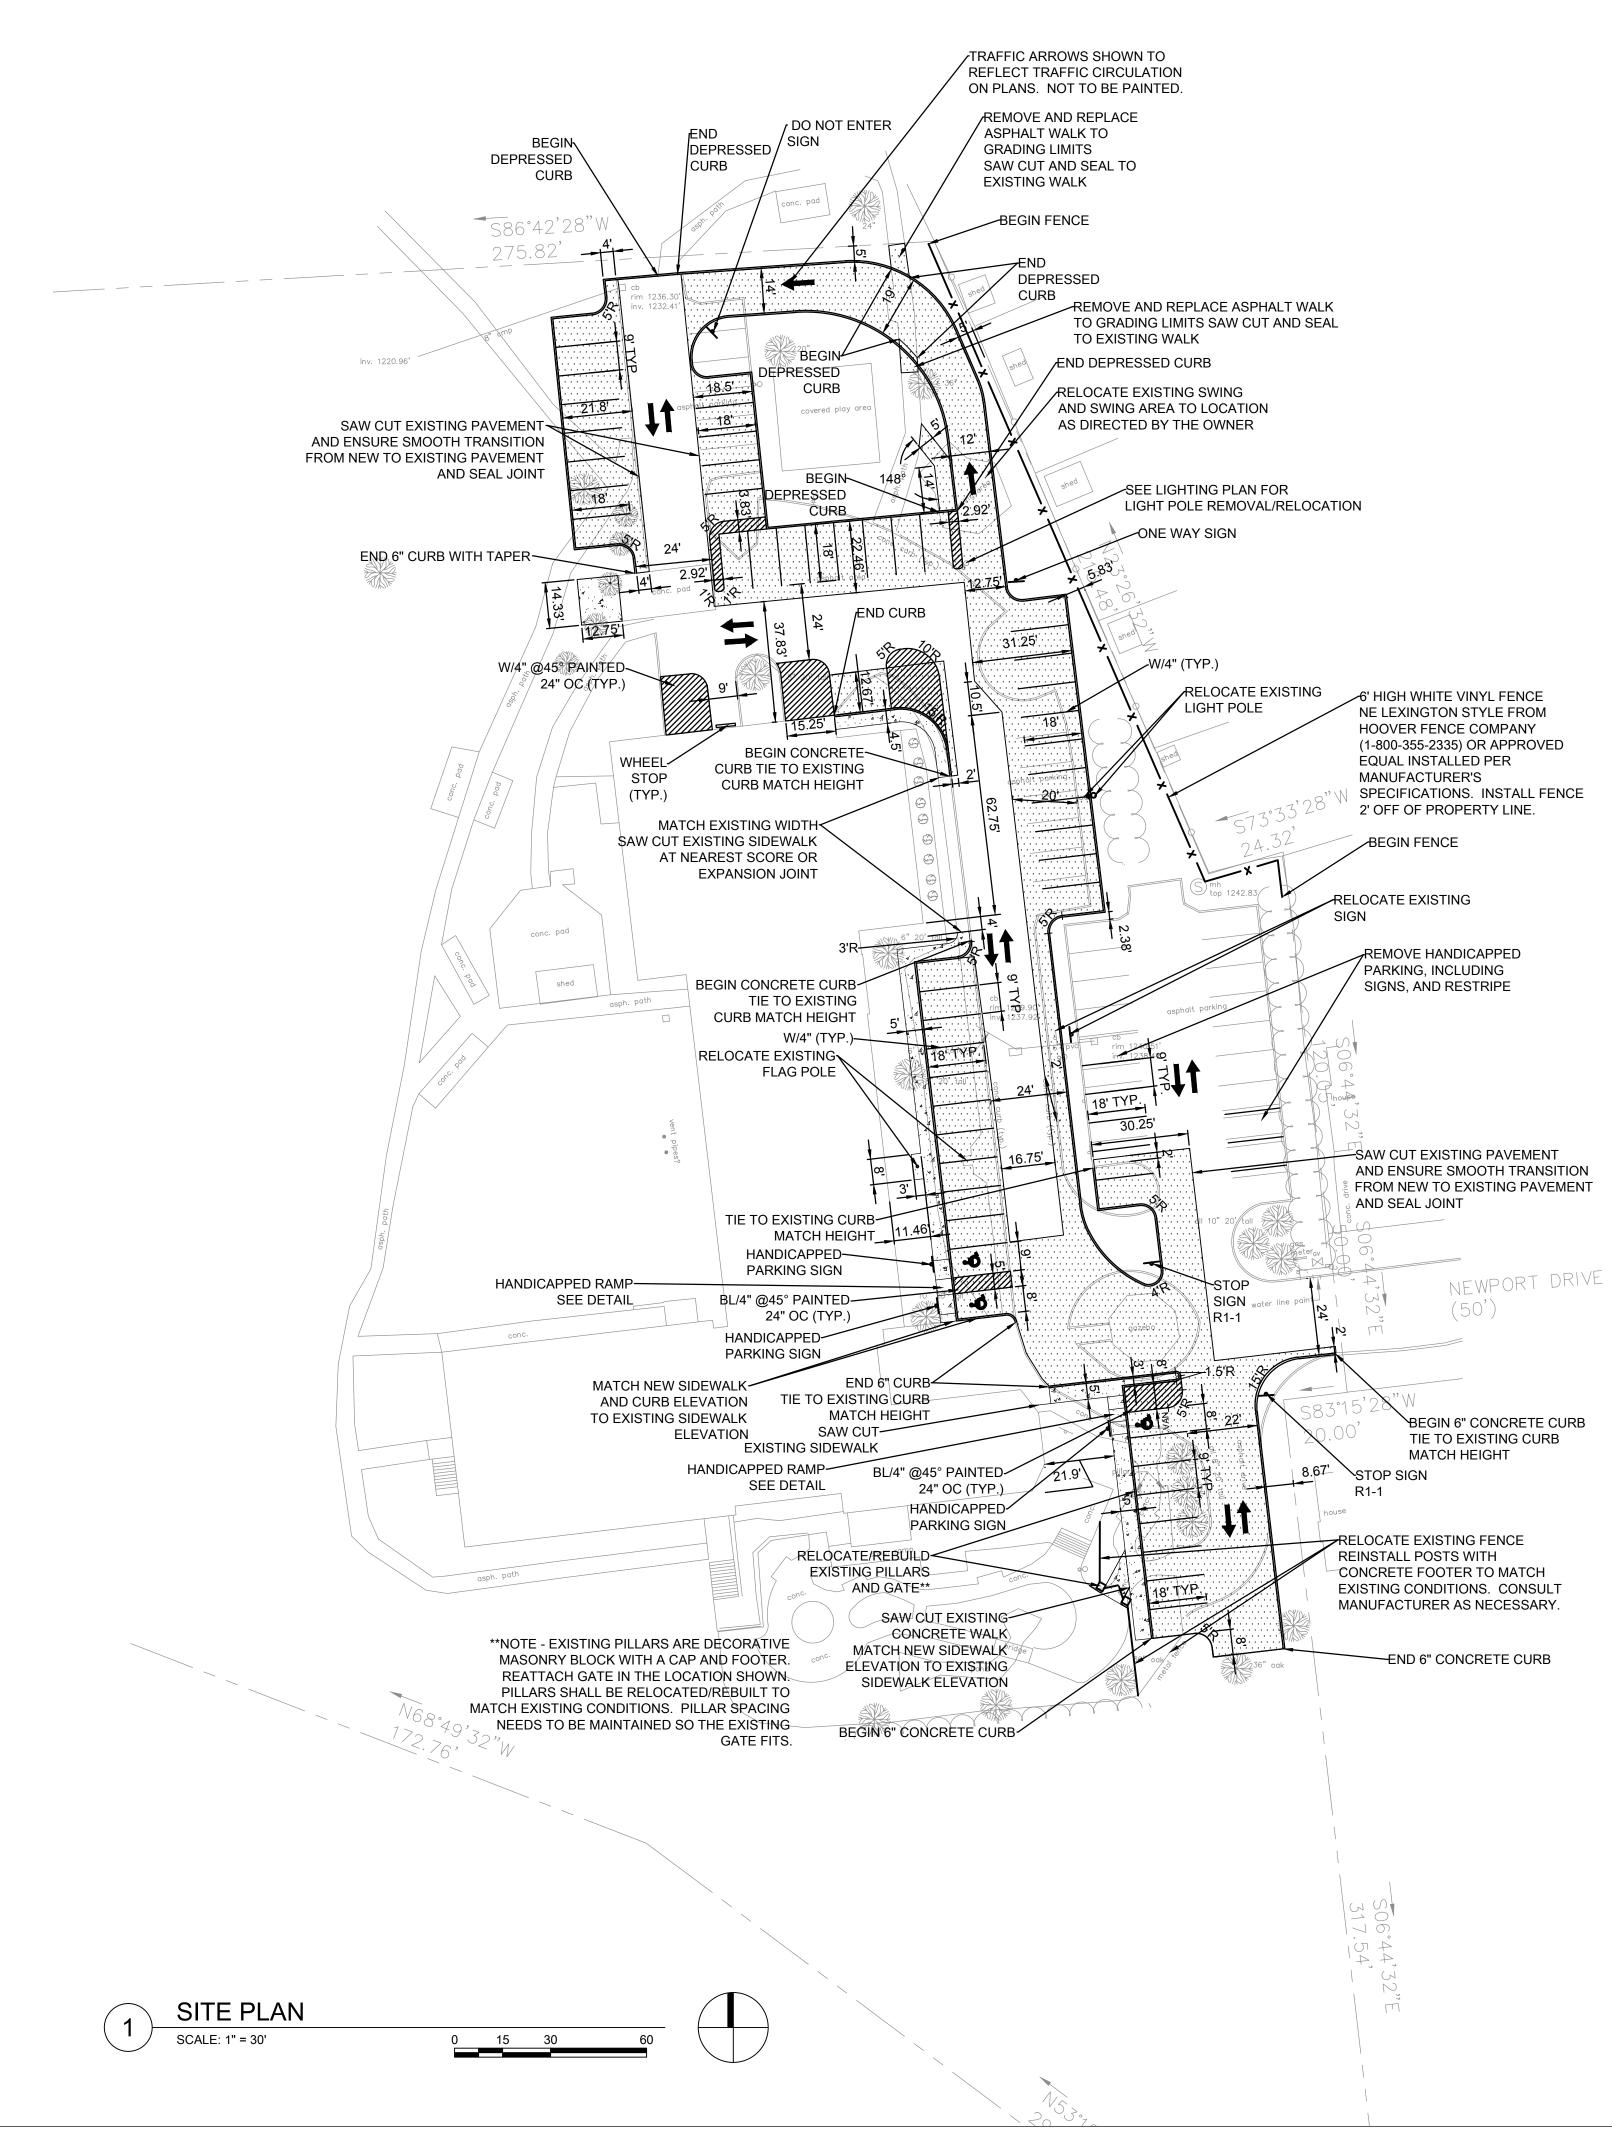
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SHEET TITLE				
SITE DEMOLITION PLAN				
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SITE PLAN NOTES:

1. All site work, materials and construction, and construction methods shall comply with Baldwin Township material and construction specifications.

2. All dimensions and radii are to the face of curb unless otherwise noted.

3. Contractor shall verify all stakeout information and notify engineer of any discrepancies prior to proceeding with work.

4. Contractor shall provide an alternate bid price to seal coat the parking lot and restripe the parking paces not being restriped as part of the base bid within the enclosed documents.

SITE PLAN LEGEND:

STANDARD-DUTY ASPHALT PAVEMENT

STANDARD-DUTY CONCRETE PAVEMENT



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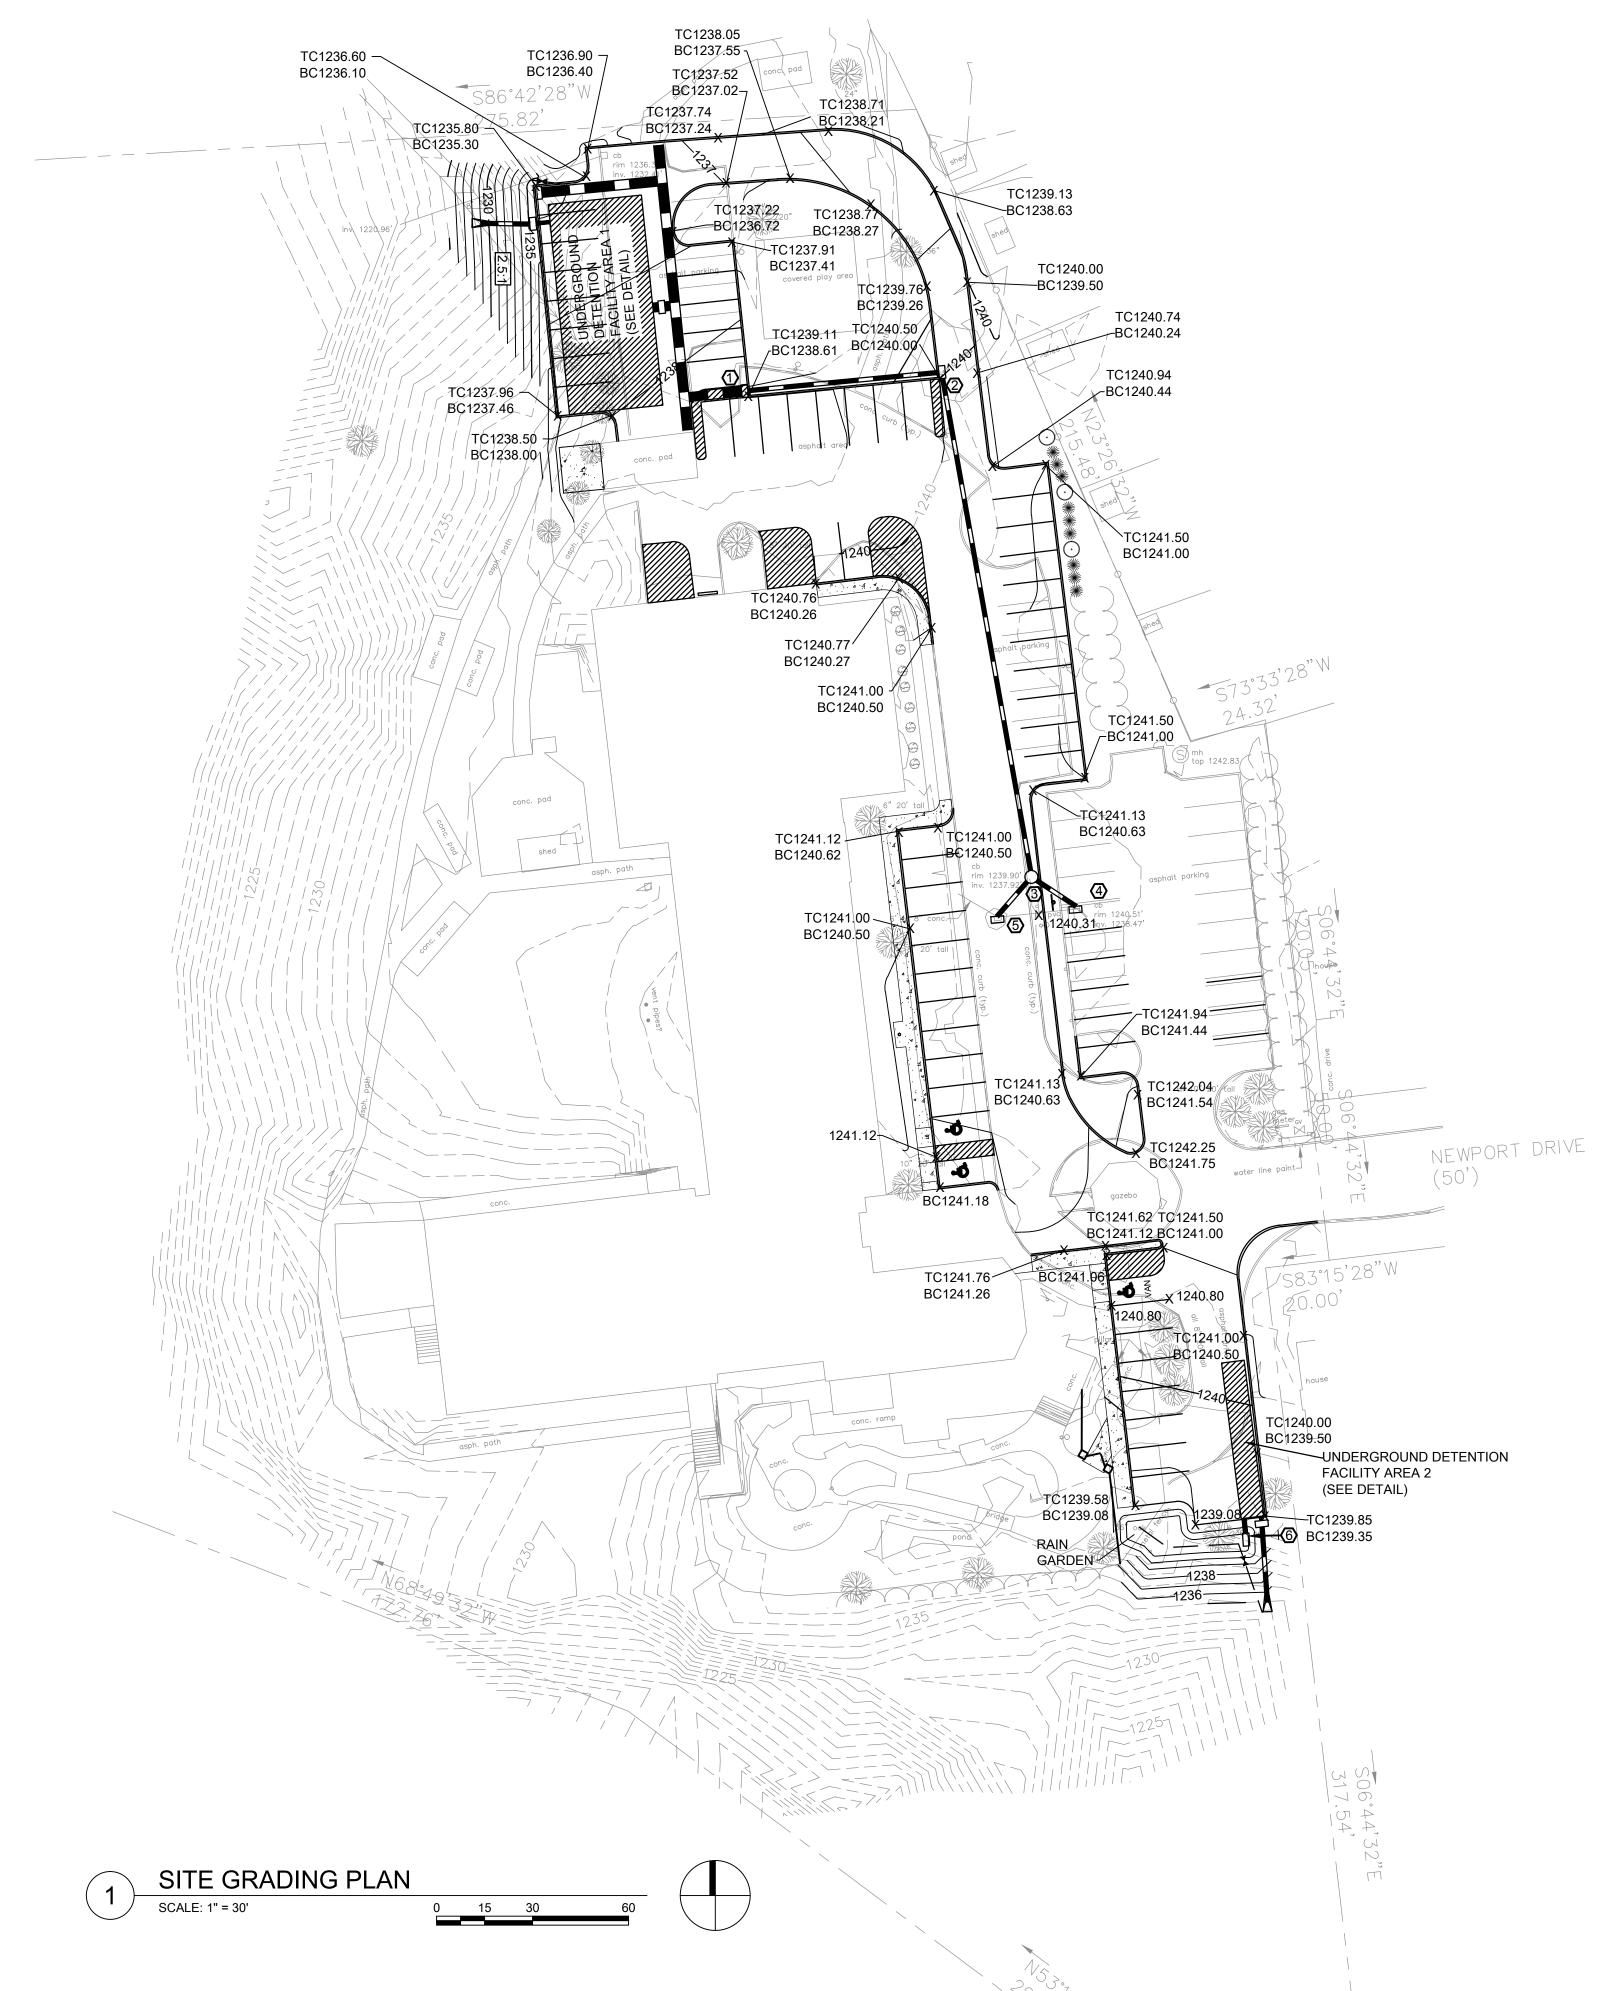
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600 NEWPORT DRIVE BALDWIN TOWNSHIP, PA 15234

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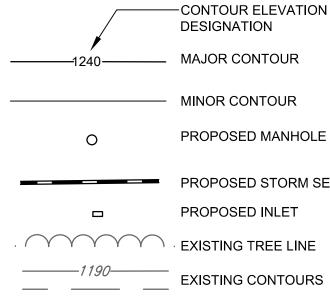
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SHEET TITLE			
SITE PLAN			
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SITE GRADING PLAN NOTES:

- 1. The Contractor shall compact pipe backfill in max. 8" loose lifts to 95% of the maximum dry density per ASTM D1557 according to the pipe bedding details. Trench bottom shall be stable in high groundwater areas.
- 2. Topsoil shall be stripped and stockpiled for use in final landscaping.
- 3. Unless otherwise indicated at a specific location, all finished grades are to conform to and match existing grades.
- 4. The Contractor shall restore any structure, pipe, utility, pavement, curbs, sidewalks, landscaped areas, etc. disturbed during construction to the original condition or better.
- 5. The Contractor shall submit shop drawings of materials and structures for review and approval prior to fabrication.
- 6. The Contractor shall preserve existing vegetation where possible and/or as noted on the drawings.
- 7. Refer to the Erosion and Sedimentation Control Plan for the limit of disturbance and notes.
- 8. The Contractor is responsible for the removal and disposal of all rubbish, trash, debris, and organic material in a lawful manner. 9. The Contractor shall be advised that all excavation is considered
- unclassified and that it shall be responsible for all means, methods, and materials of construction to complete construction as designed. Additionally, the Contractor shall be responsible for the off-site disposal of any and all excess or unsuitable material unable to be placed on site and the importation of any borrow material necessary to complete the job.
- 10. Site grading shall be performed to provide positive drainage to catch basins and to preclude the ponding of water on the site.
- 11. Verify required spot elevations/grading in the vicinity of the buildings with the existing conditions.
- 12. All slopes shall be 3:1 or flatter unless otherwise specified. All slopes greater than 3:1 shall be stabilized with erosion control blanketing.
- 13. Existing and proposed grades shown at 1' contour intervals.
- 14. Contractor shall adjust and/or cut existing pavement as needed to ensure smooth fit and continuous grade.
- 15. Contractor shall ensure positive drainage away from buildings.
- 16. Sidewalks shall have a maximum 2.0% cross slope.

SITE GRADING PLAN LEGEND:



-CONTOUR ELEVATION DESIGNATION MAJOR CONTOUR MINOR CONTOUR PROPOSED MANHOLE PROPOSED STORM SEWER PROPOSED INLET



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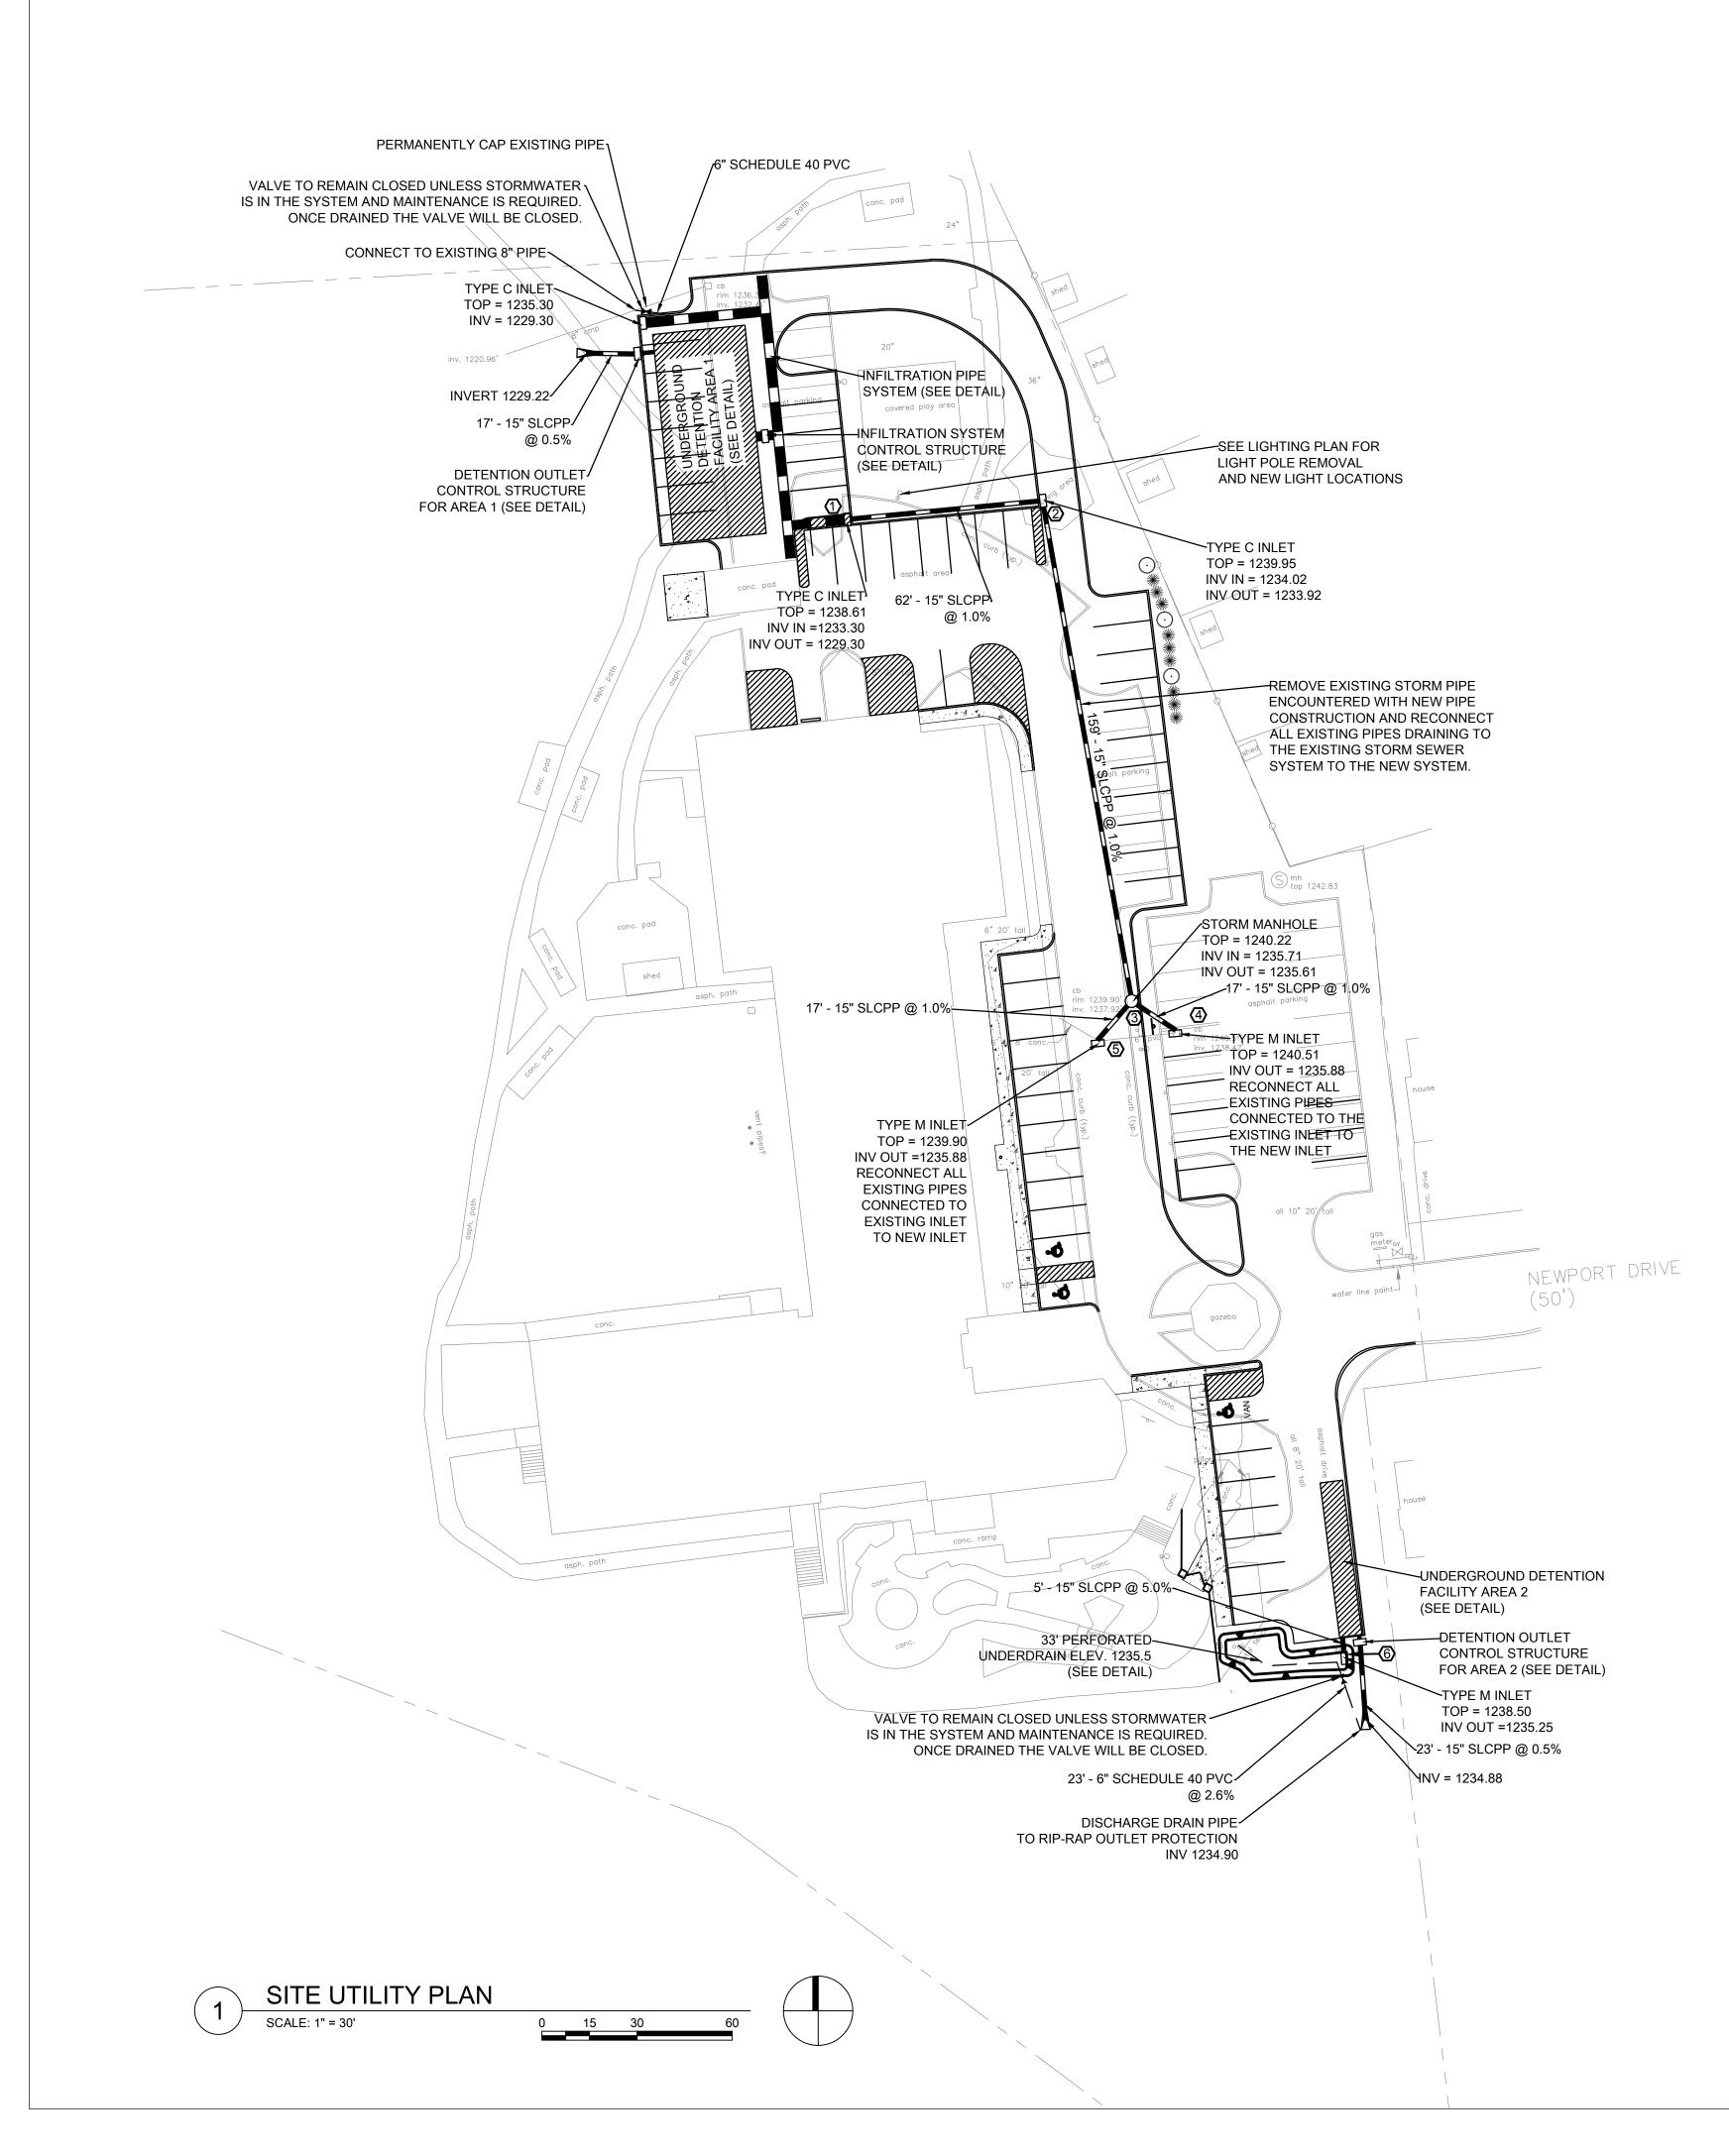
YOUNG SCHOLARS PARKING LOT PROJECT

BALDWIN TOWNSHIP ALLEGHENY COUNTY, PA DEVELOPER:

YOUNG SCHOLARS WESTERN PA CHARTER SCHOOL

600 NEWPORT DRIVE BALDWIN TOWNSHIP, PA 15234

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SHEET TITLE			
SITE GRADING PLAN			
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UTILITY PLAN NOTES:

1. See electrical plans for light pole information.

- Storm sewer pipes shall be laid on straight alignments and even grades using a pipe laser or other accurate method.
- 3. Site Contractor shall provide all bends, fittings, adapters, etc. as required for pipe connections.
- All valve lids, manholes, inlet tops, etc. affected or set by the construction shall be adjusted to finish grade elevation.
- All fill materials to be in place and compacted before installation of proposed utilities.
- Underground lines shall be installed, inspected and approved before backfilling.
- 7. Existing utilities shall be verified in field prior to installation of any new lines.
- 8. The contractor is specifically cautioned that the location and/or elevation of existing utilities as shown on these plans is based on records of the various utility companies, and where possible, measurements taken in the field. The information is not to be relied on as being exact or complete. The contractor must call the appropriate utility companies at least 72 hours before any excavation to request exact field location of utilities. It shall be the responsibility of the contractor to relocate all existing utilities which conflict with the proposed improvements shown on the plans.
- Contractor is responsible for all necessary inspections and/or certifications required by codes and/or utility companies.
- 10. Valve for the rain garden and storm infiltration system shall be a commercial valve that extends to grade for ease of maintenance/draining operations in difficult weather conditions.

UTILITY PLAN LEGEND:

0	PROPOSED MANHOLE
	PROPOSED STORM SEWER
	PROPOSED INLET
\bigcirc	STORM SEWER STRUCTURE ID
X	VALVE AND VALVE BOX
A	HDPE END SECTION



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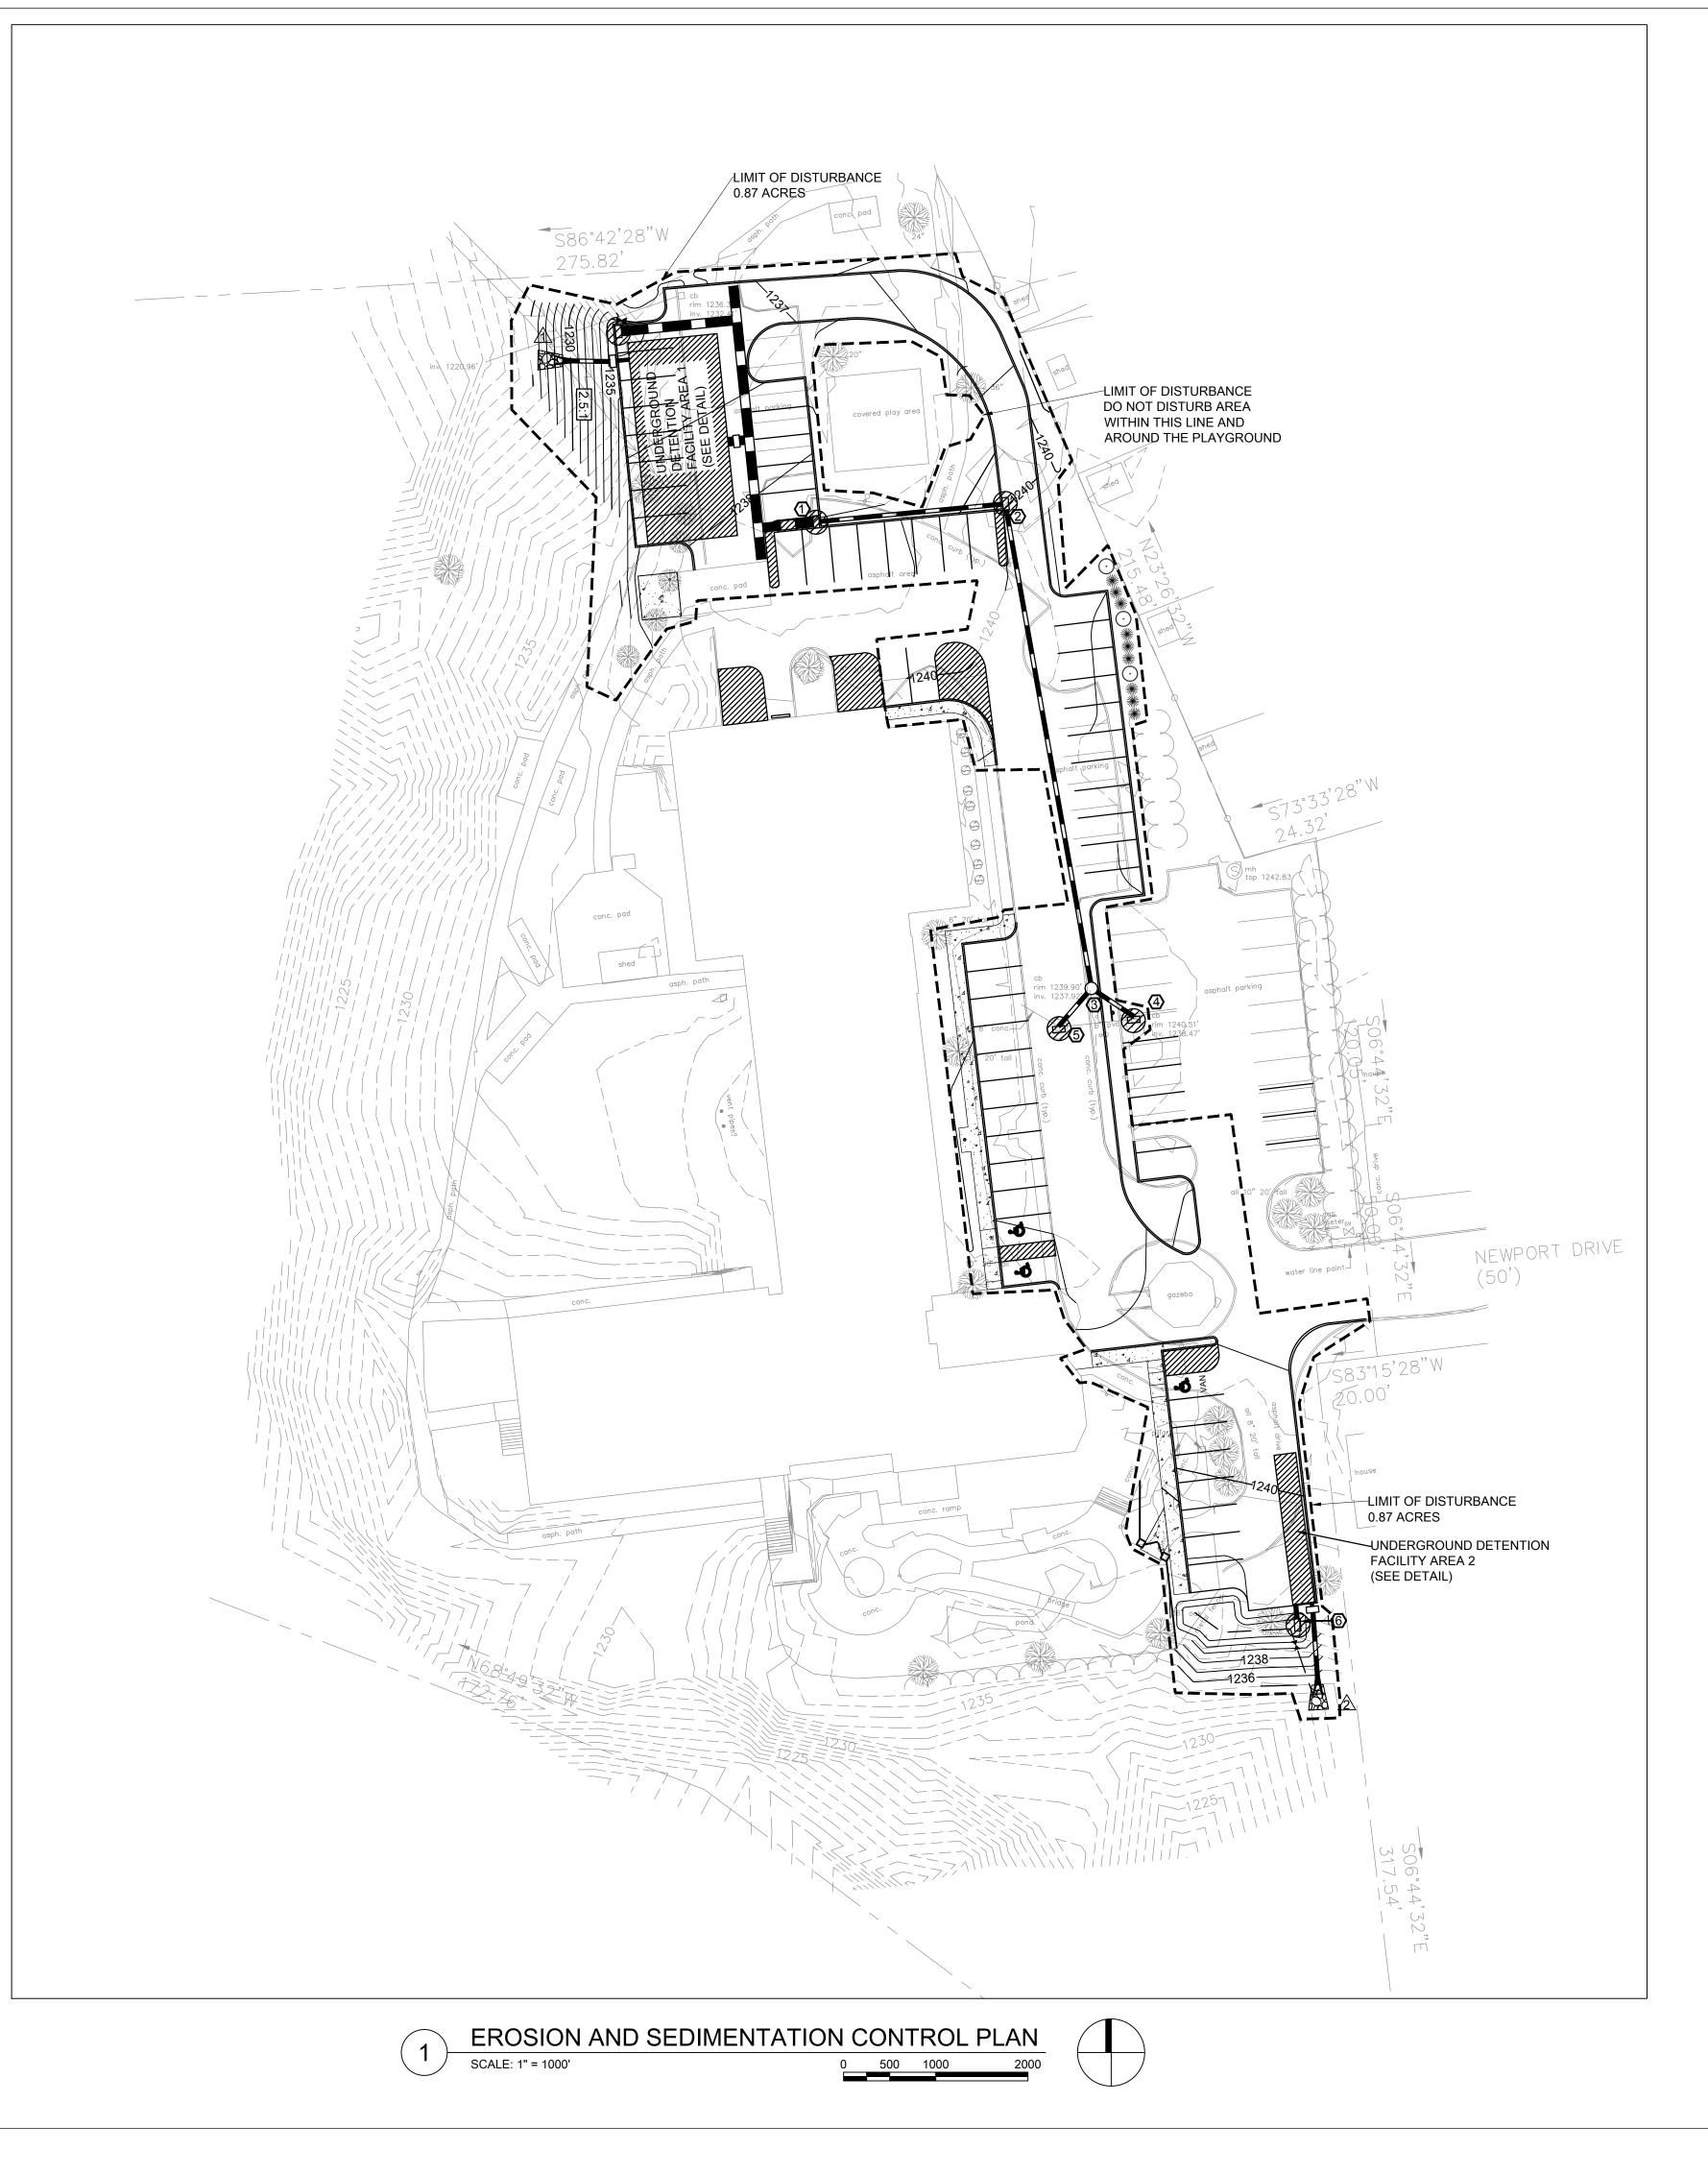
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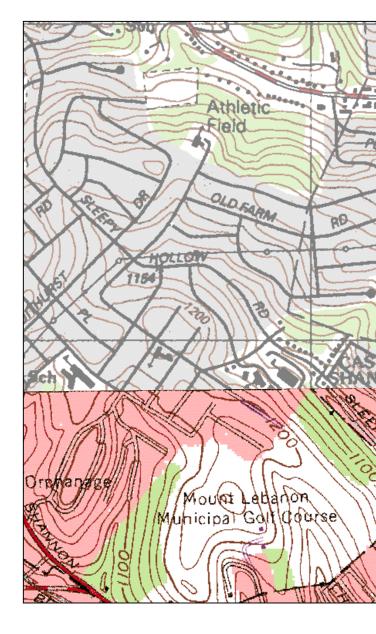
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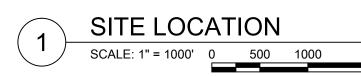
YOUNG SCHOLARS WESTERN PA CHARTER SCHOOL

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SHEET TITLE				
SITE UTILITY PLAN				
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CONSTRUCTION SEQUENCE

- Each step in the construction sequence shall be completed before initiation of the next step.
- 2. Install inlet protection to existing inlets and install silt fences as shown on the plans.
- 3. Contractor shall provide additional erosion and sedimentation control devices as necessary based on site conditions and weather patterns during construction.
- 4. If at any time during construction sediment laden water cannot be diverted to the silt fences or inlet protection it must be pumped though a filter bag facility such as the one shown on the Erosion and Sediment Control Detail sheet before being discharged to the existing storm system.
- 5. Stabilize all areas disturbed with the erosion and sedimentation controls.
- 6. Clear and grub the area to the north of the existing building where the parking lot will be added and remove all trees as shown on the demolition plan. Relocate the existing swings as directed by the owner.
- 7. Remove all items as shown on the demolition plan.
- 8. Install the underground detention facilities and infiltration pipe system including outlet protection.
- 9. Construct the rain garden on the south end of the site.
- 10. Install the storm sewers beginning at the downstream end of the system and working upstream. Install inlet protection to inlets as they are installed.
- 11. Construct the pavement courses and sidewalks.
- 12. Stabilize all areas not previously stabilized with seed and mulch.
- 13. 70% uniform permanent vegetative cover over the entire site must be established in all tributary areas before erosion and sedimentation BMP's can be removed. Once vegetated, temporary controls may be removed.

LEGEND

LIMIT OF DISTURBANCE

 \oslash

SILT FENCE

INLET PROTECTION

RIP RAP OUTLET PROTECTION AND IDENTIFICATION



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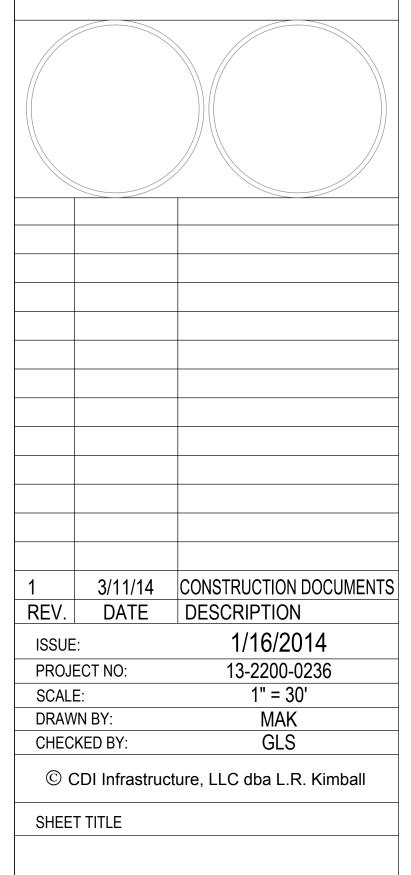
YOUNG SCHOLARS PARKING LOT PROJECT

BALDWIN TOWNSHIP ALLEGHENY COUNTY, PA DEVELOPER:

YOUNG SCHOLARS WESTERN PA CHARTER SCHOOL

600 NEWPORT DRIVE BALDWIN TOWNSHIP, PA 15234


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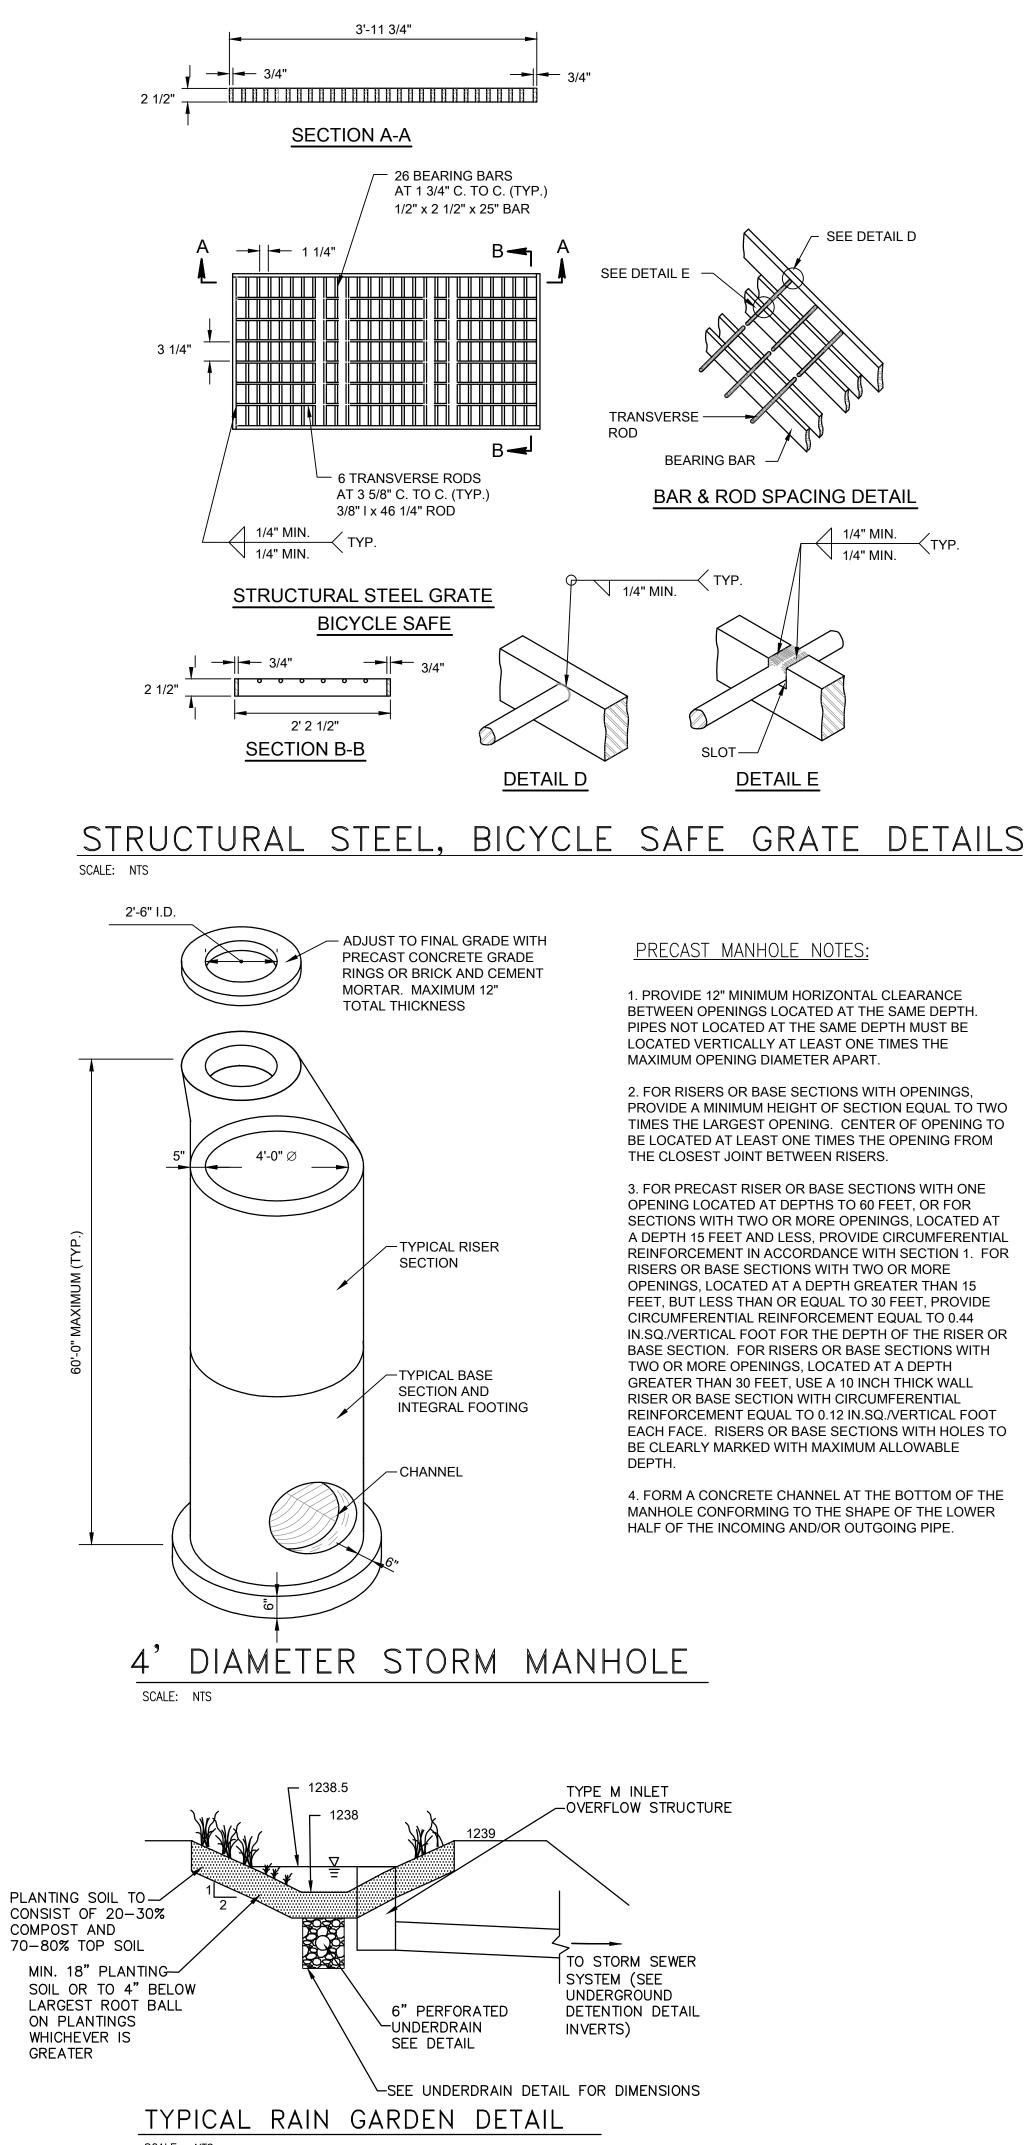


EROSION AND SEDIMENTATION CONTROL PLAN


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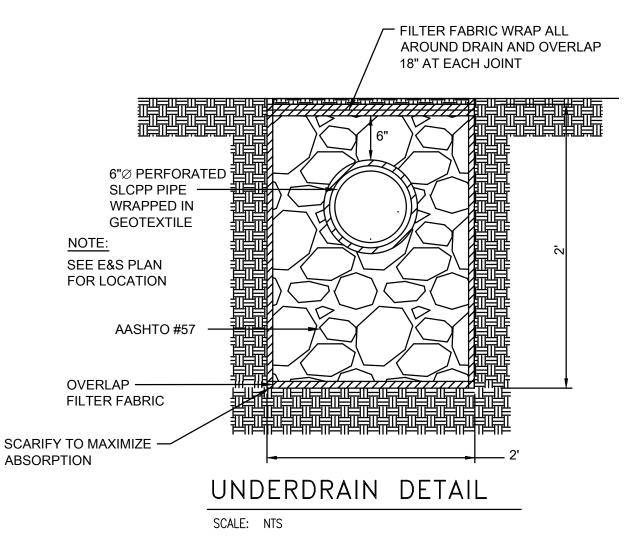





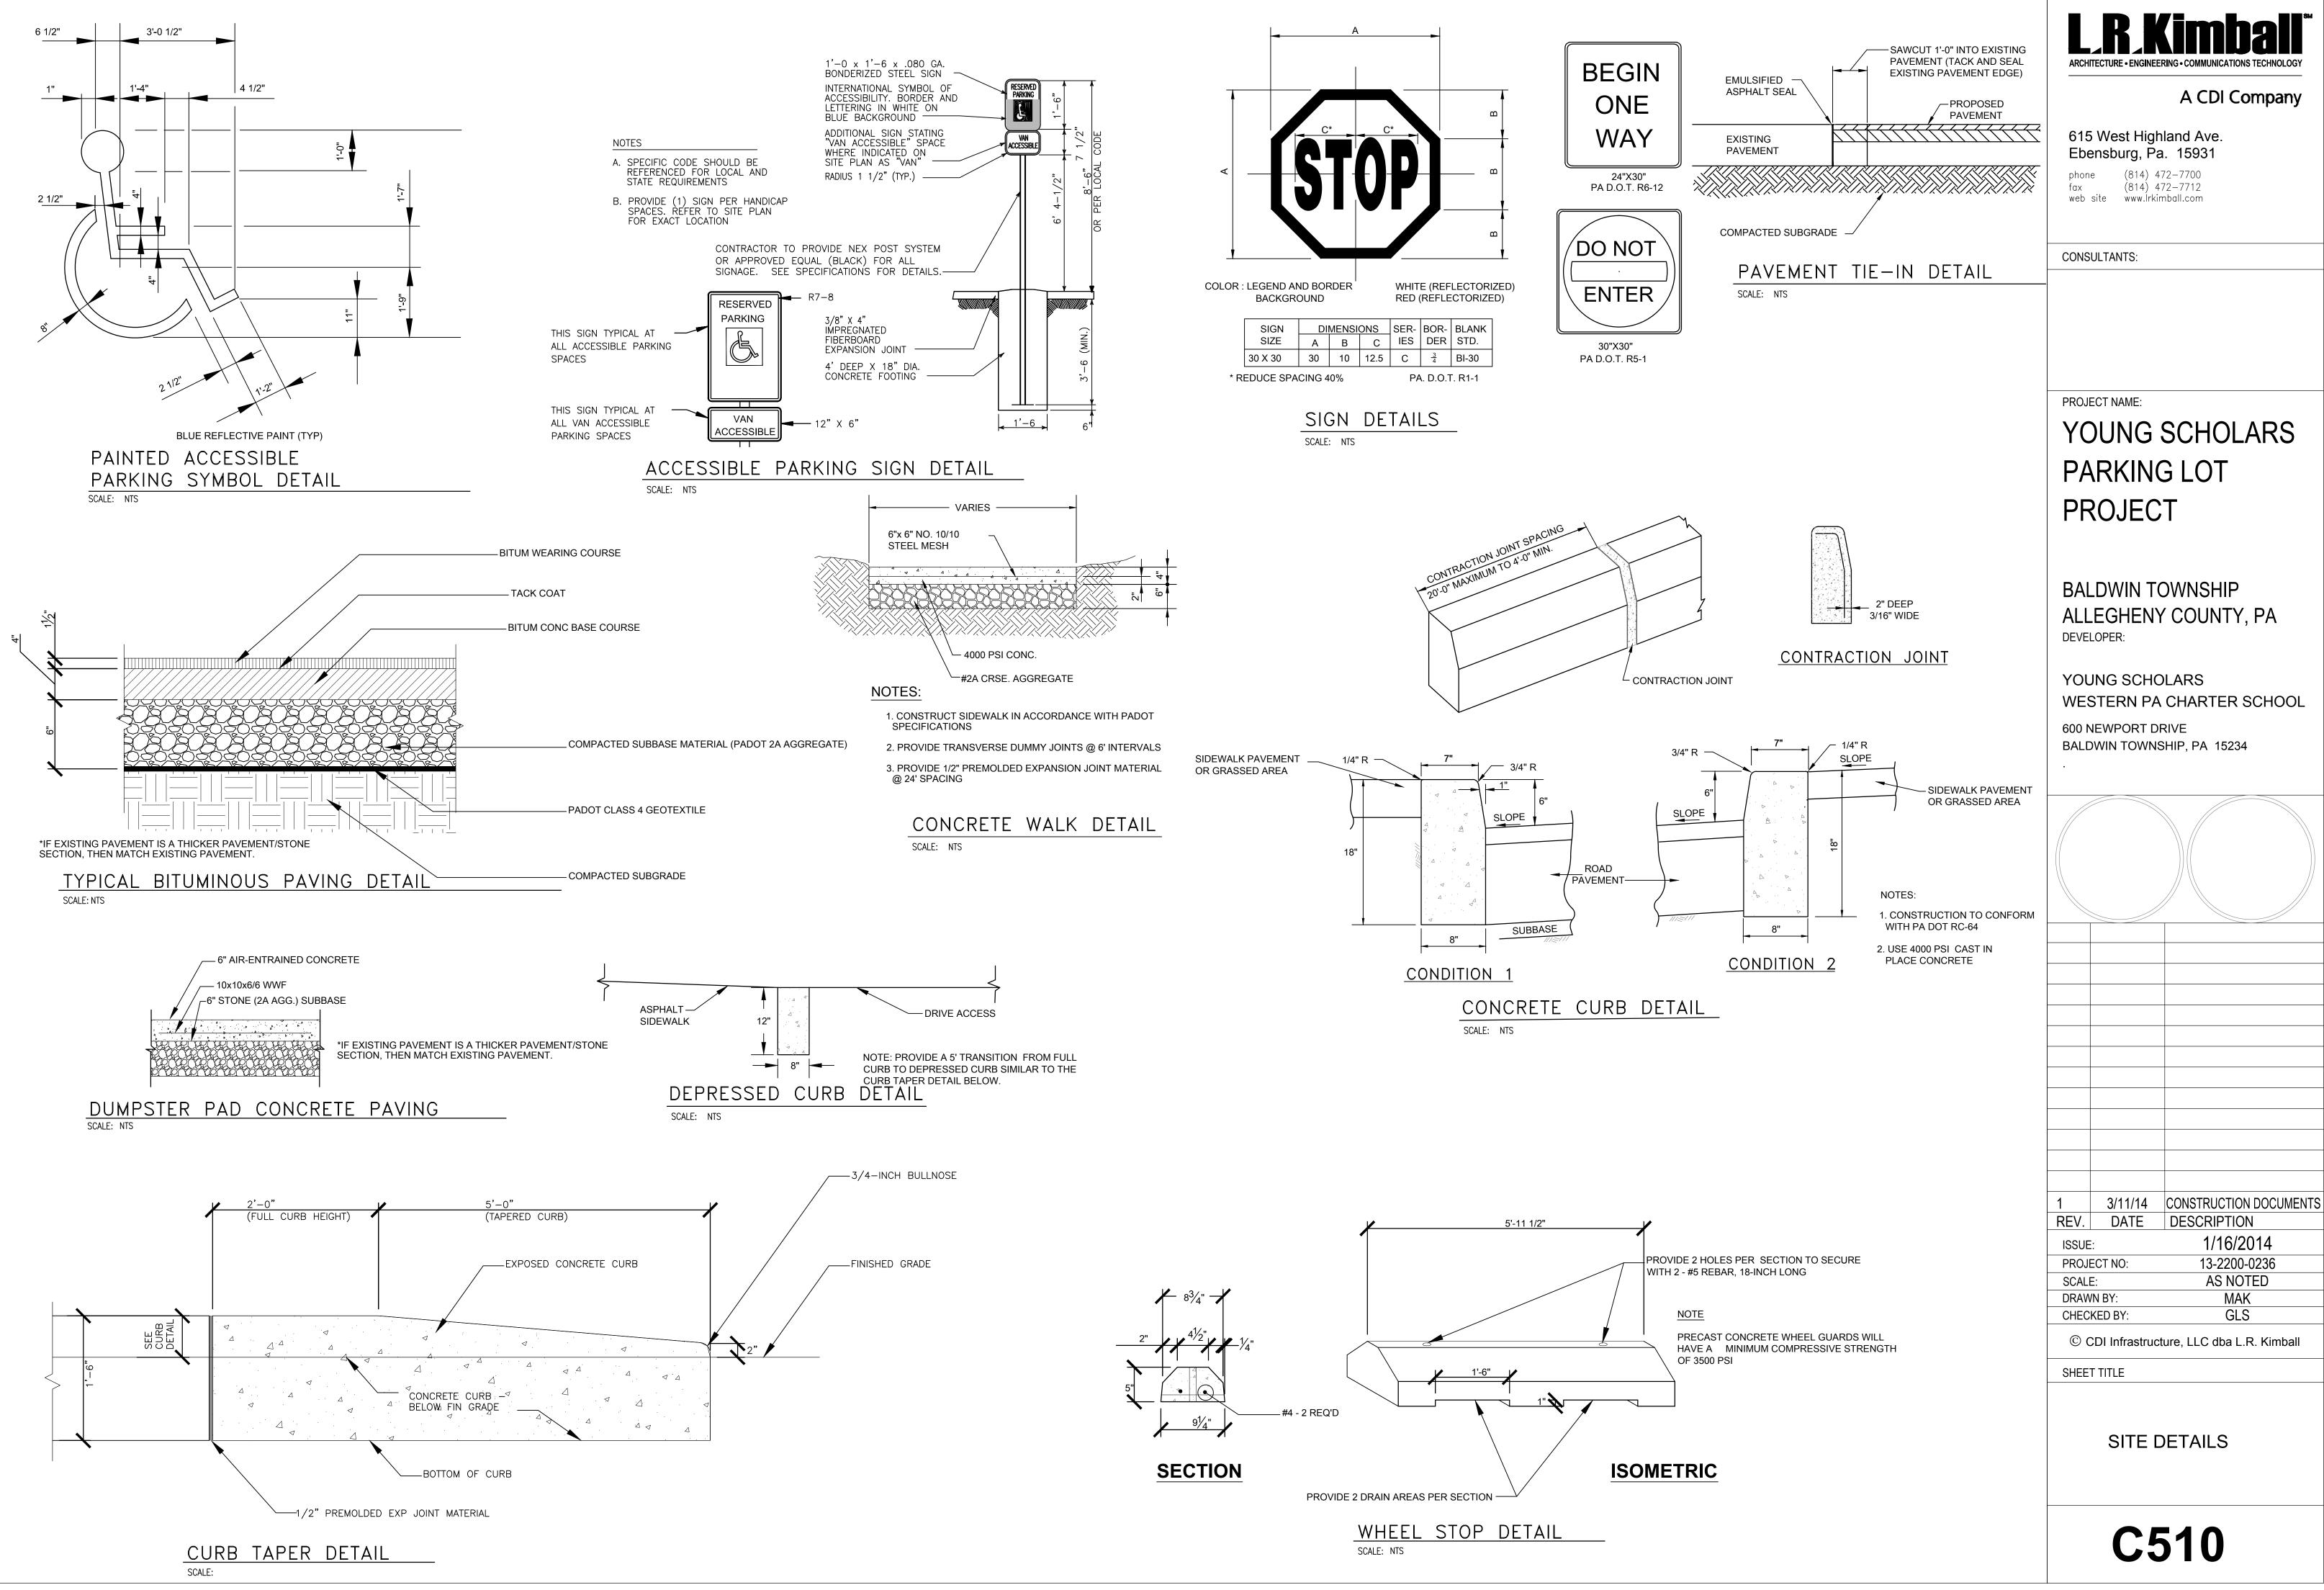


SCALE: NTS



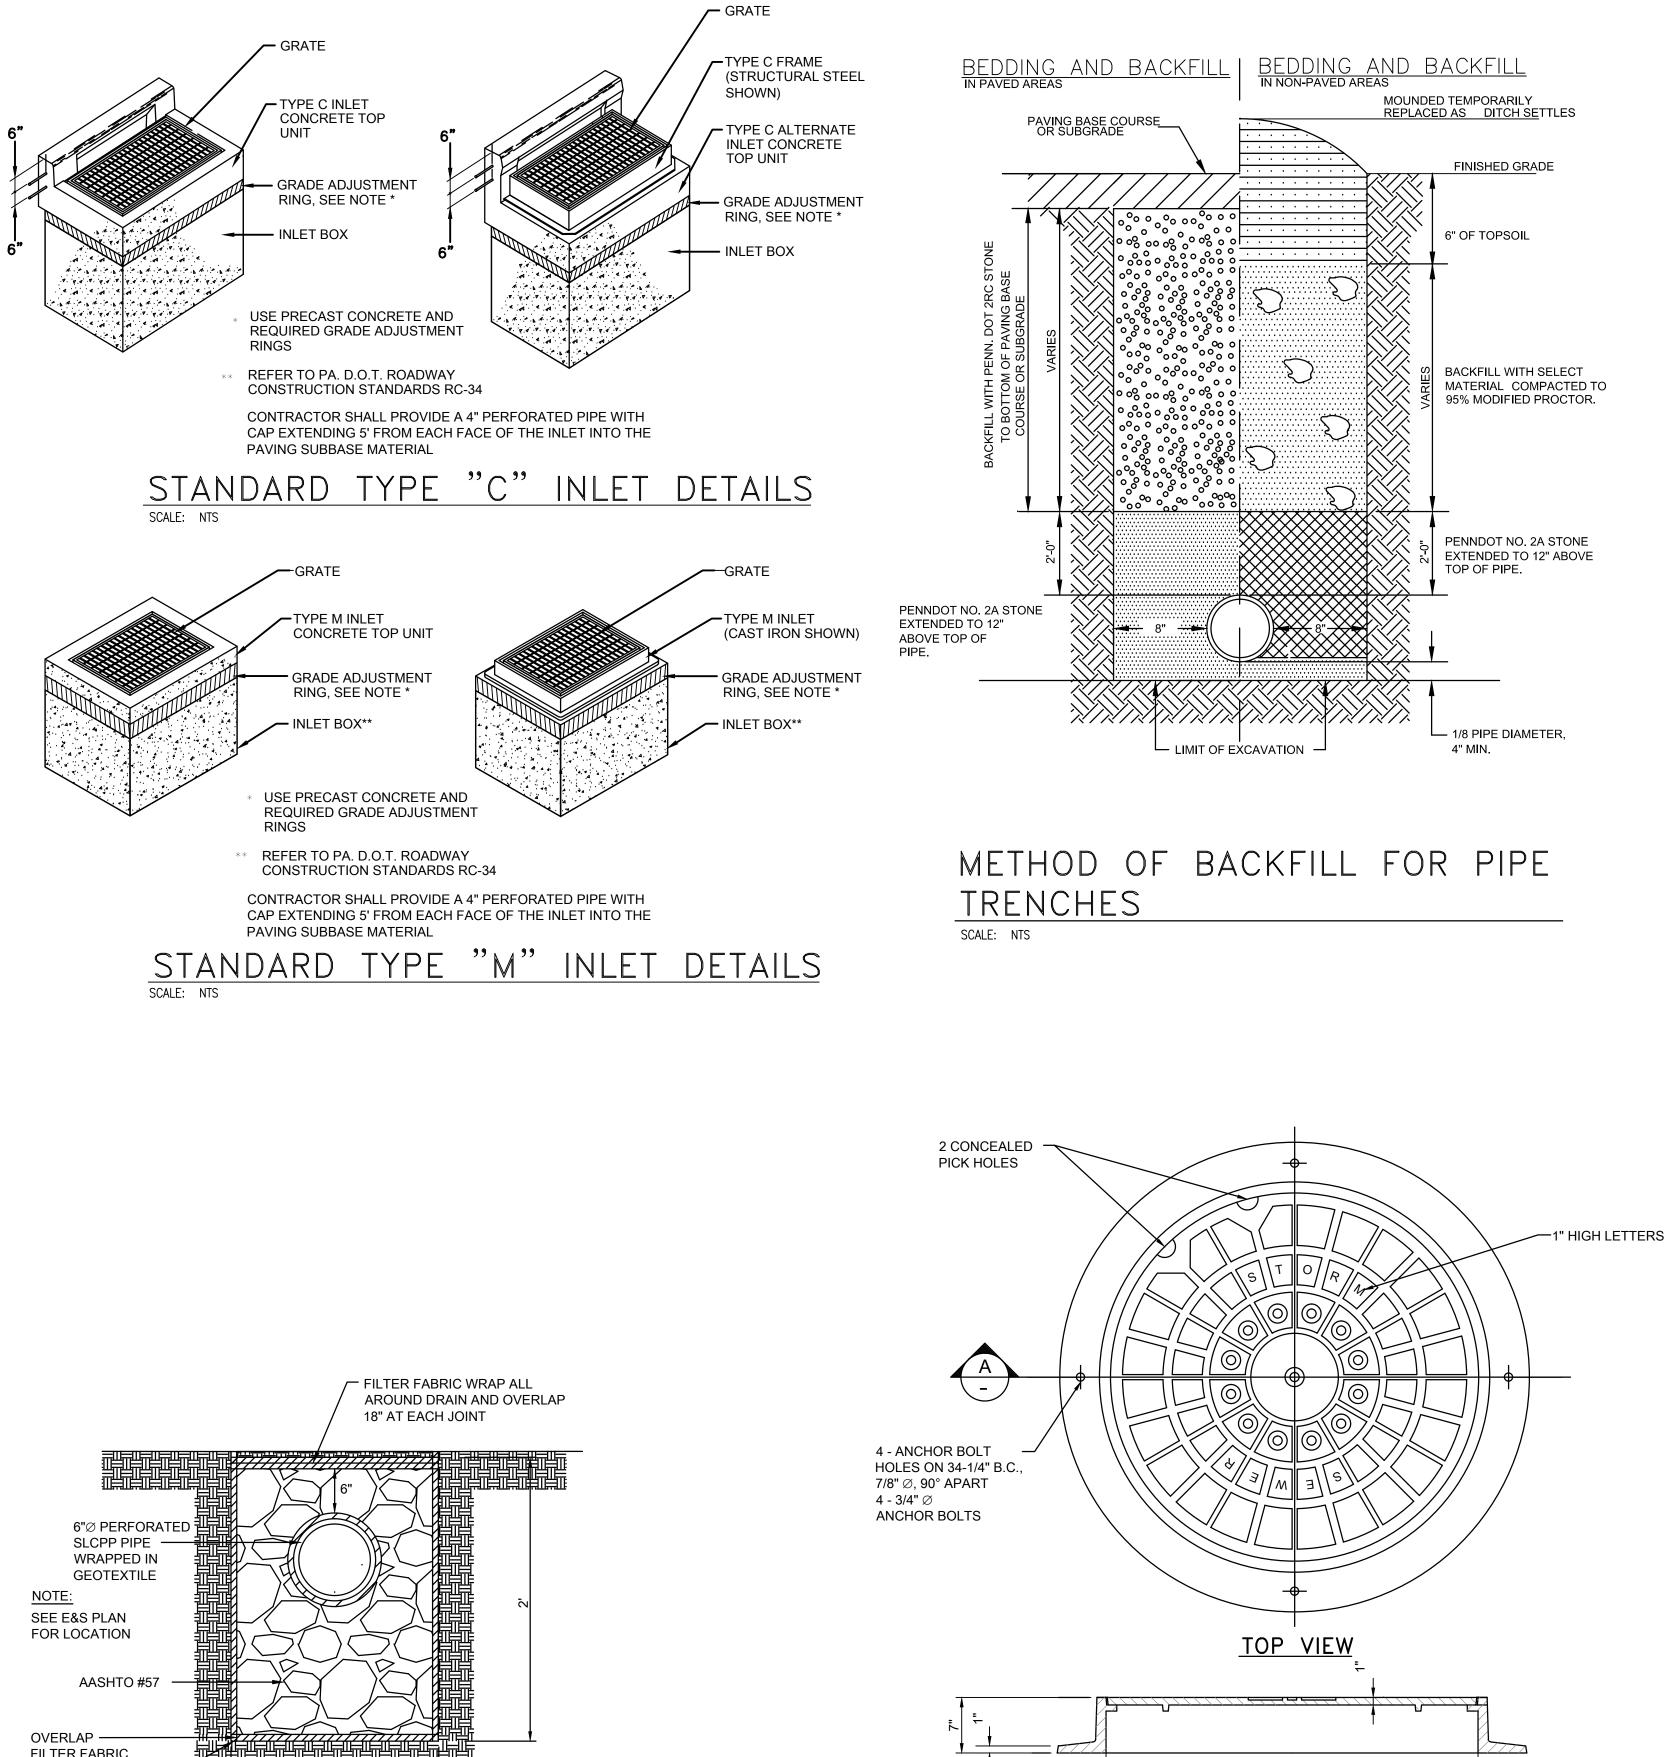

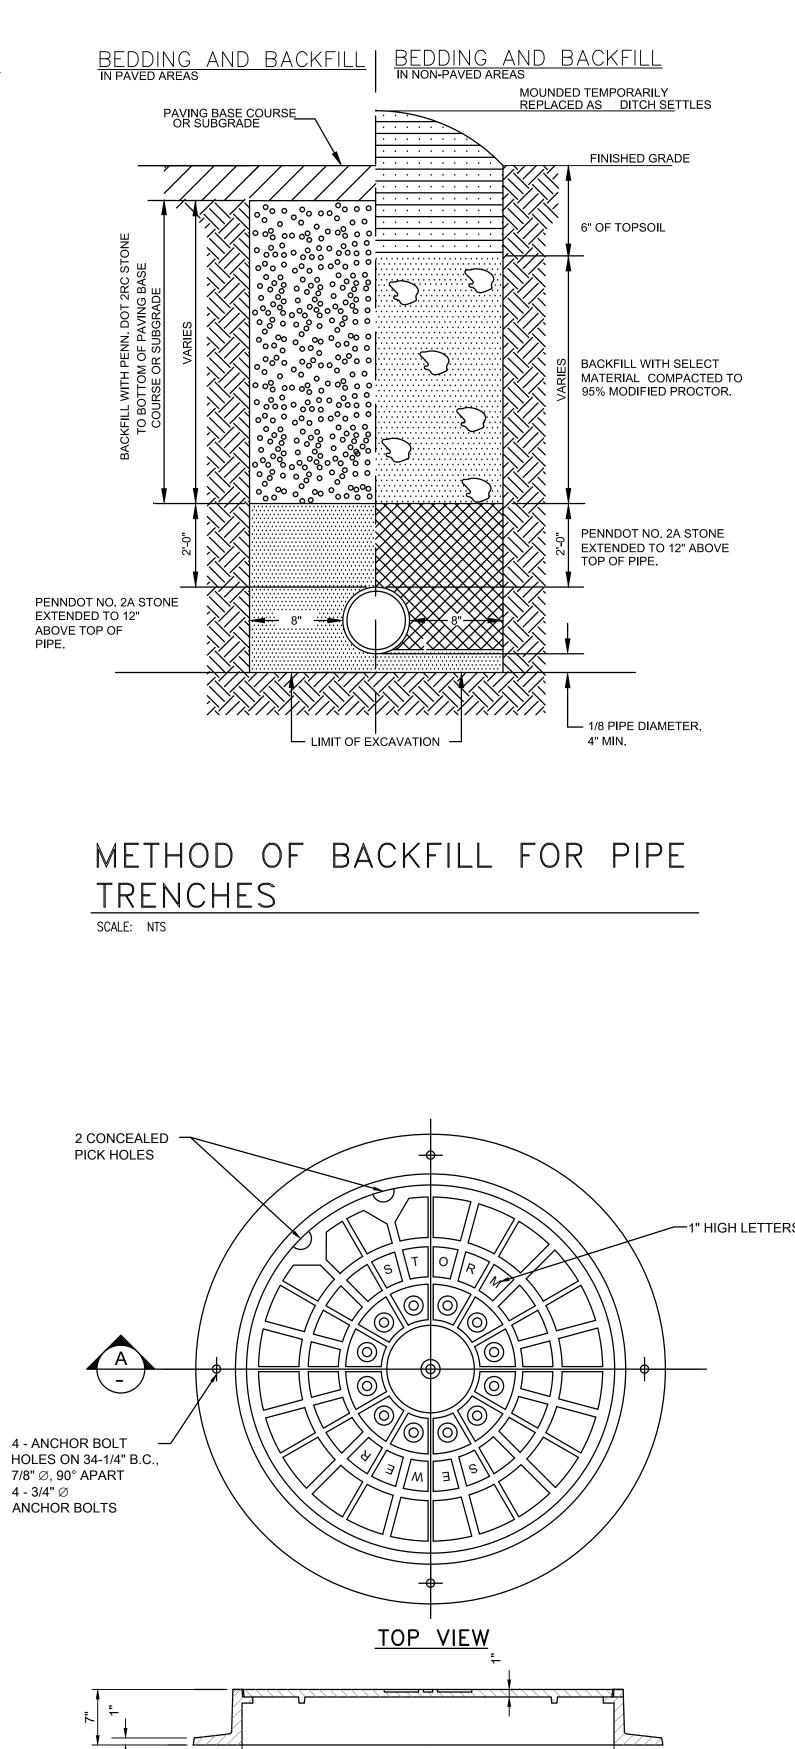

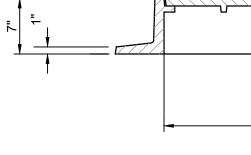

MANHOLE COVER AND FRAME SCALE: NTS

30"

SECTION A-A



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CONSULTANTS:

PROJECT NAME:

YOUNG SCHOLARS **PARKING LOT** PROJECT

BALDWIN TOWNSHIP ALLEGHENY COUNTY, PA DEVELOPER:

YOUNG SCHOLARS WESTERN PA CHARTER SCHOOL

600 NEWPORT DRIVE BALDWIN TOWNSHIP, PA 15234

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STORMWATER CONVEYANCE/DETENTION SYSTEM MAINTENANCE NOTES

THE INSPECTION/MAINTENANCE OF THE CONVEYANCE SYSTEM SHOULD CONSIST OF THE FOLLOWING TASKS:

- 1. INSPECT THE INLET BOXES AND PIPING SYSTEM FOR ANY GROWING BRUSH, TRASH, OR OBSTRUCTIONS, AND REMOVE ANY MATERIAL THAT COULD POSSIBLY BLOCK THE DOWNSTREAM PIPING.
- 2. REMOVE ANY TRASH THAT HAS BUILT UP WITHIN THE INLET BOXES, OR IS CAUGHT IN THE GRATES OF THE INLETS. THE TRASH SHALL BE REMOVED TO AN OFF-SITE LOCATION AND DISPOSED OF IN A LAWFUL MANNER.
- 3. INSPECT THE CLEANOUTS FOR ANY SIGNS OF WEAR OR DESTRUCTION OF THE PIPING SYSTEM OR FOR ANY EXCESS SEDIMENT DEPOSITS THAT IS NOT CONSISTENT WITH NORMAL OPERATION. IF PRESENT, CONTACT THE SITE ENGINEER OR A REPRESENTATIVE FROM THE TOWNSHIP IMMEDIATELY.
- 4. THE PROPERTY OWNER/DEVELOPER, YOUNG SCHOLAR WESTERN PA CHARTER SCHOOL., SHALL BE RESPONSIBLE FOR MAINTENANCE OF THE STORMWATER MANAGEMENT SYSTEM BEING CONSTRUCTED AS PART OF THIS PROJECT.

GENERAL CONSTRUCTION SEQUENCE NOTES

1. ALL EARTH DISTURBANCE ACTIVITIES SHALL PROCEED IN ACCORDANCE WITH THE CONSTRUCTION SEQUENCE. CLEARING AND GRUBBING SHALL BE LIMITED ONLY TO THOSE AREAS DESCRIBED.

2. BEFORE IMPLEMENTATION ANY REVISIONS TO THE APPROVED EROSION AND SEDIMENT CONTROL PLAN OR REVISIONS TO OTHER PLANS WHICH MAY AFFECT THE EFFECTIVENESS OF THE APPROVED E&S CONTROL PLAN, THE OPERATOR MUST RECEIVE APPROVAL OF THE REVISIONS FROM THE SITE ENGINEER OR COUNTY CONSERVATION DISTRICT.

3. THE OPERATOR SHALL REMOVE FROM THE SITE, RECYCLE OR DISPOSE OF ALL BUILDING MATERIALS AND WASTES IN ACCORDANCE WITH THE DEPARTMENT'S SOLID WASTE MANAGEMENT REGULATIONS AT 25 PA CODE 260.1 ET SEQ., 271.1 E. SEQ. AND 287.1 ET SEQ.

4. BEFORE DISPOSING OF SOIL OR RECEIVING BORROW FOR THE SITE, THE OPERATOR MUST PROVIDE PROOF THAT EACH SPOIL OR BORROW AREA HAS AN EROSION AND SEDIMENT CONTROL PLAN APPROVED BY THE ALLEGHENY COUNTY CONSERVATION DISTRICT, AND WHICH IS BEING IMPLEMENTED AND MAINTAINED ACCORDING TO CHAPTER 102 REGULATIONS.

5. ANY FILL MATERIAL IMPORTED TO THE SITE SHALL BE "CLEAN" FILL IN ACCORDANCE WITH PADEP REGULATIONS AND CONSTRUCTION SPECIFICATIONS. ENVIRONMENTAL DUE DILIGENCE SHALL BE USED AND MEANS THAT EVERY EFFORT SHALL BE MADE TO ENSURE THAT THE LAND BEING PURCHASED/DEVELOPED DOES NOT POSE ANY POTENTIAL RISKS OR ENVIRONMENTAL HAZARDS THAT MAY AFFECT THE AREA'S DEVELOPMENT OR ITS FUTURE OCCUPANTS.

RAINGARDEN MAINTENANCE AND INSPECTION

CONSTRUCTION SEQUENCE

1. REFER TO THE CONSTRUCTION SEQUENCE ON THE EROSION AND SEDIMENTATION CONTROL PLANS FOR RAINGARDEN INSTALLATION INSTRUCTIONS.

2. STABILIZE GRADING WITHIN THE LIMIT OF DISTURBANCE EXCEPT WITHIN THE RAINGARDEN AREA. RAINGARDEN BED AREAS MAY BE USED AS TEMPORARY SEDIMENT TRAPS PROVIDED THAT THE PROPOSED FINISHED ELEVATION OF THE BED IS 12 INCHES LOWER THAN THE BOTTOM ELEVATION OF THE SEDIMENT TRAP.

3. EXCAVATE THE RAINGARDEN TO PROPOSED INVERT DEPTH OR TO THE BOTTOM OF THE AGGREGATE BED AND SCARIFY THE EXISTING SOIL SURFACES. DO NOT COMPACT THE IN-SITU SOILS.

4. BACKFILL THE RAINGARDEN WITH THE AMENDED SOIL AS SHOWN ON THE PLANS AND SPECIFICATIONS. OVERFILLING IS RECOMMENDED TO ACCOUNT FOR SETTLEMENT. LIGHT HAND TAMPING IS ACCEPTABLE IF NECESSARY.

5. PRESOAK THE PLANTING SOIL PRIOR TO PLANTING VEGETATION TO AID IN SETTLEMENT.

6. COMPLETE FINAL GRADING TO ACHIEVE PROPOSED DESIGN ELEVATIONS, LEAVING SPACE FOR UPPER LAYER OF COMPOST, MULCH OR TOPSOIL AS SPECIFIED ON THE PLANS.

7. PLANT VEGETATION.

8. MULCH AND INSTALL EROSION PROTECTION AT SURFACE FLOW ENTRANCES WHERE NECESSARY

MAINTENANCE AND INSPECTION

1. WHILE VEGETATION IS BEING ESTABLISHED, PRUNING AND WEEDING MAY BE REQUIRED.

2. DETRITUS MAY ALSO NEED TO BE REMOVED EVERY YEAR. PERENNIAL PLANTINGS MAY BE CUT DOWN AT THE END OF THE GROWING SEASON.


3. MULCH SHOULD BE RE-SPREAD WHEN EROSION IS EVIDENT AND BE REPLENISHED AS NEEDED. ONCE EVERY 2 TO 3 YEARS THE ENTIRE AREA MAY REQUIRE MULCH REPLACEMENT.

4. RAINGARDEN AREAS SHOULD BE INSPECTED AT LEAST 2 TIMES PER YEAR FOR SEDIMENT BUILDUP, EROSION, VEGETATIVE CONDITIONS, ETC.

5. DURING PERIODS OF EXTENDED DROUGHT, RAINGARDEN AREAS MAY REQUIRE WATERING.

	Y CONTROL
BITUMINOUS PAVEMENT SECTION - STONE (AASHTO # 57 OVER 3' DIAMETER PIPES	URE
GEOTEXTILE FABRIC 1' AASHTO#57 ON TOP, BOTTOM AND SIDE OF PIPES	24" RISER (1
36" CORRUGATED PERFORATED PLASTIC PIPE (TYP.) SCALE: N.T.S.	
INFUTRATION FACILITY	(

SCALE: NTS

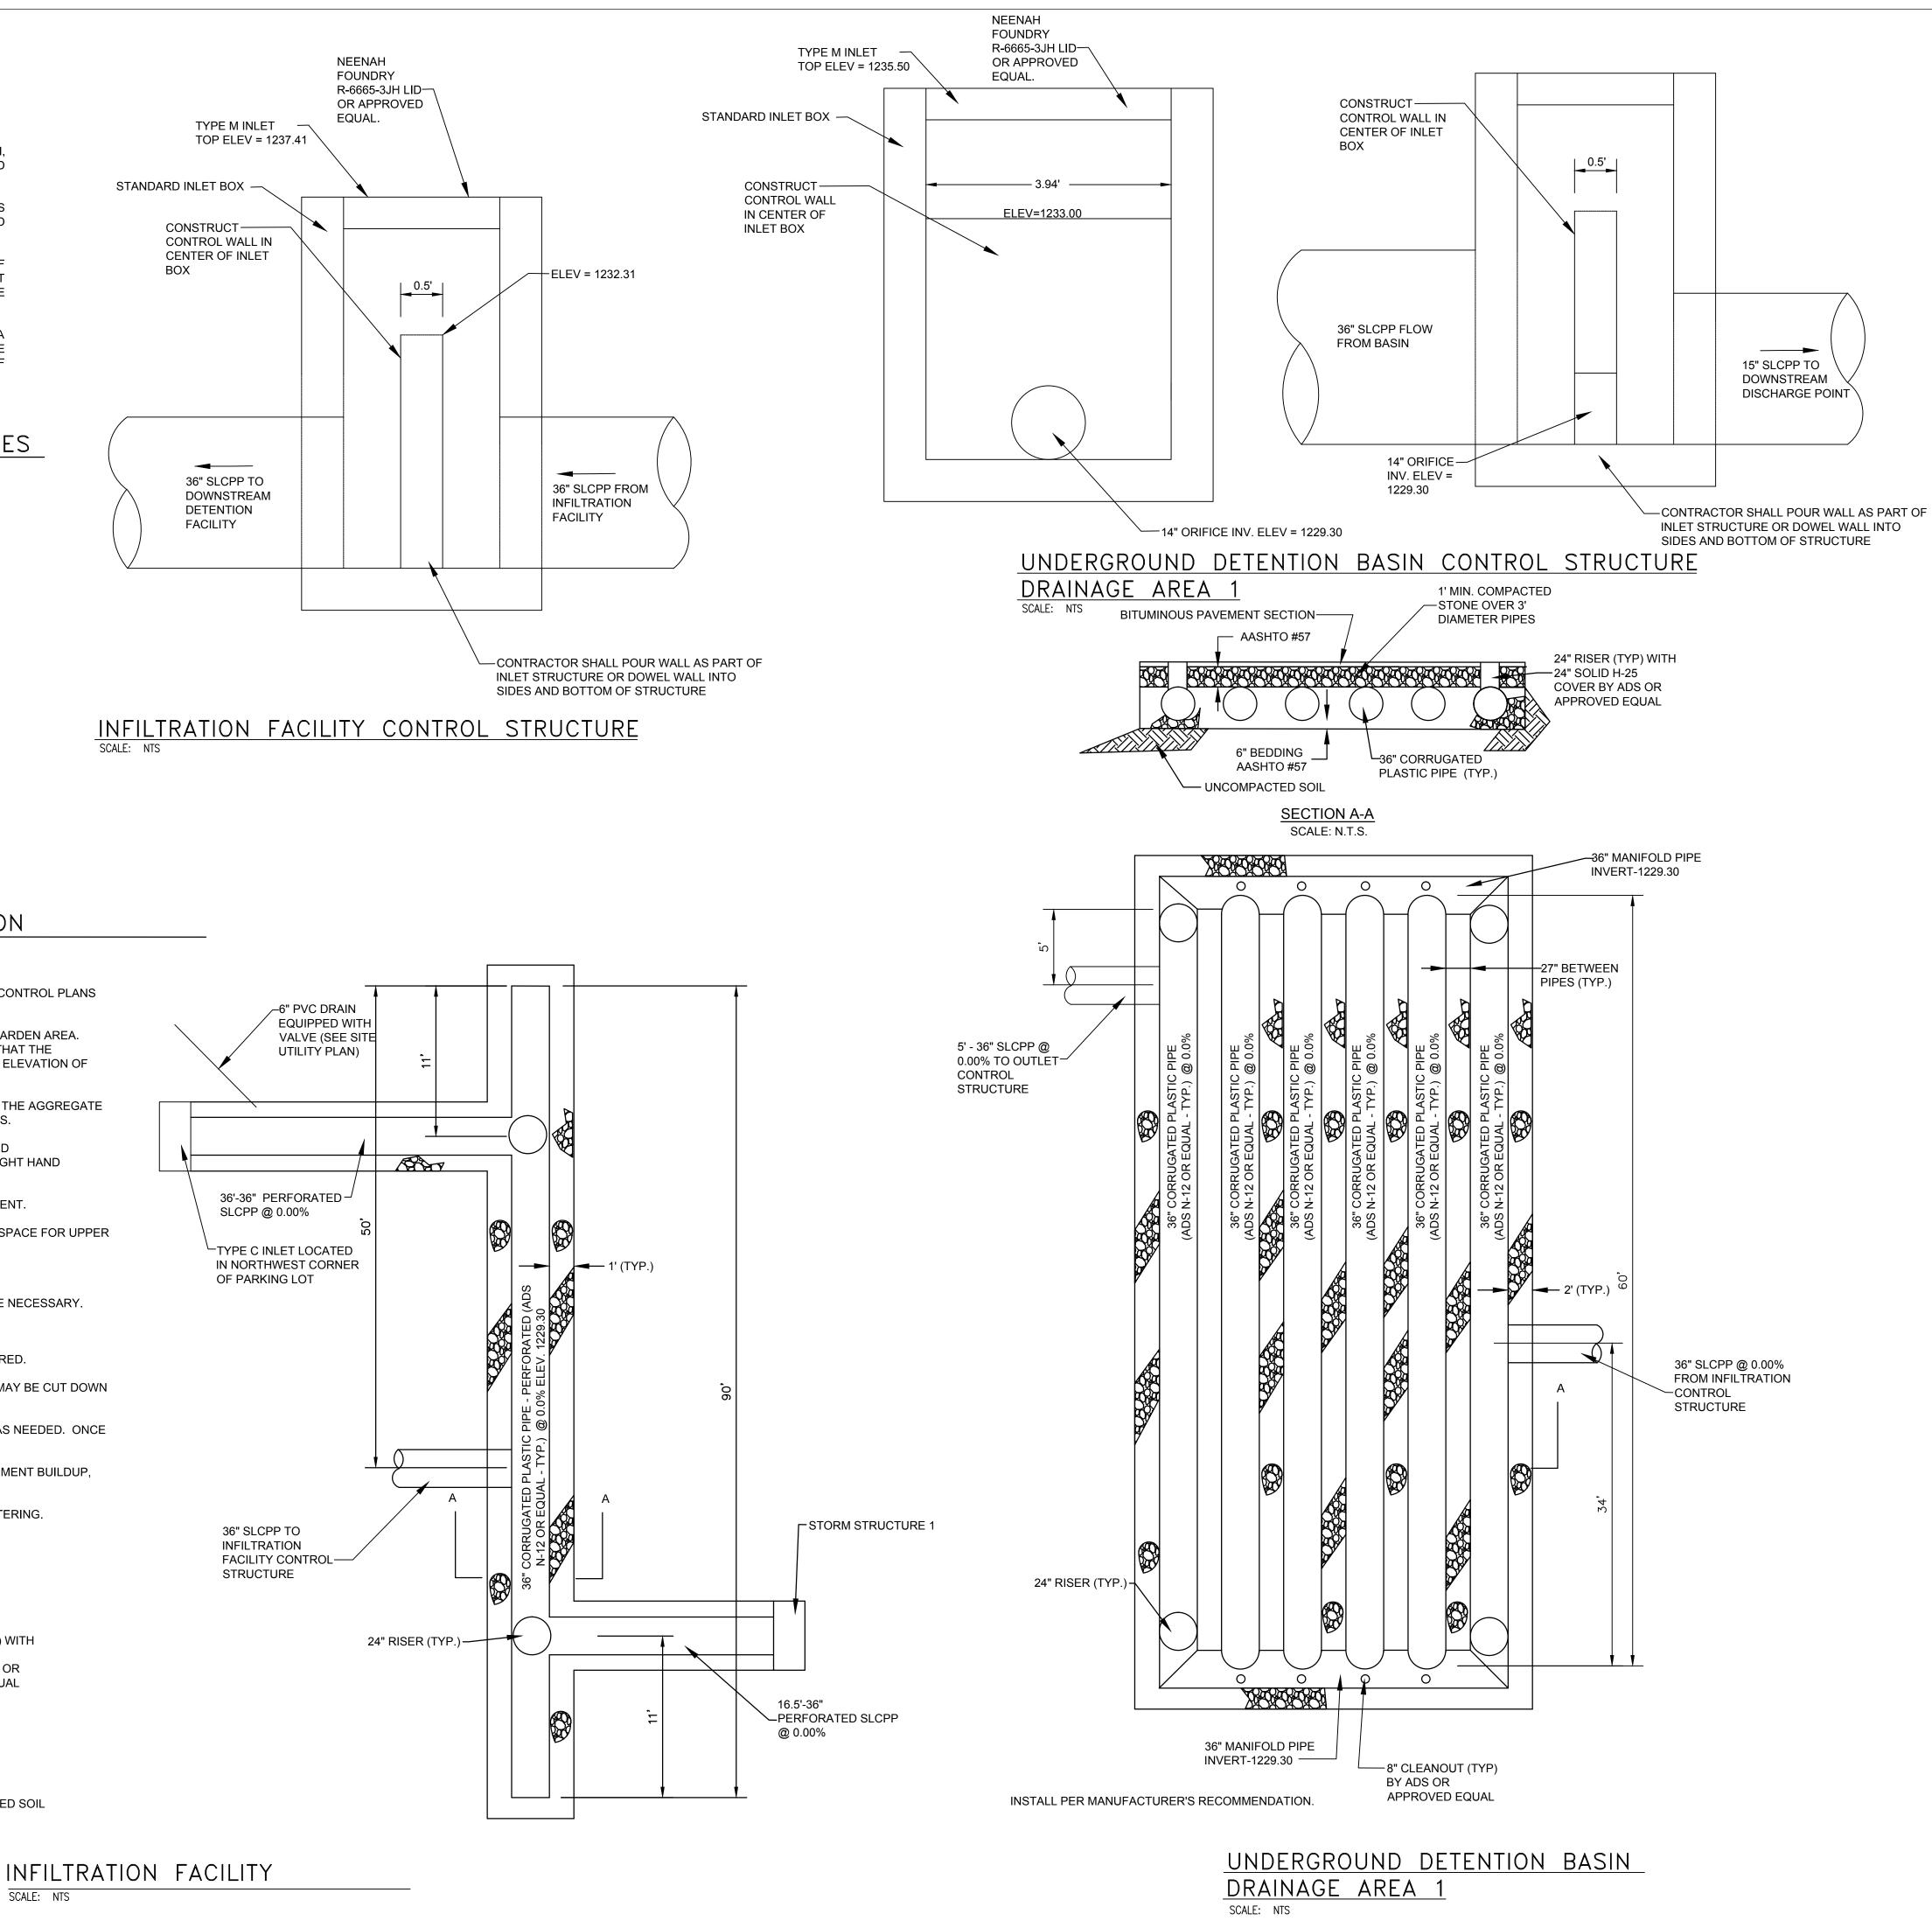



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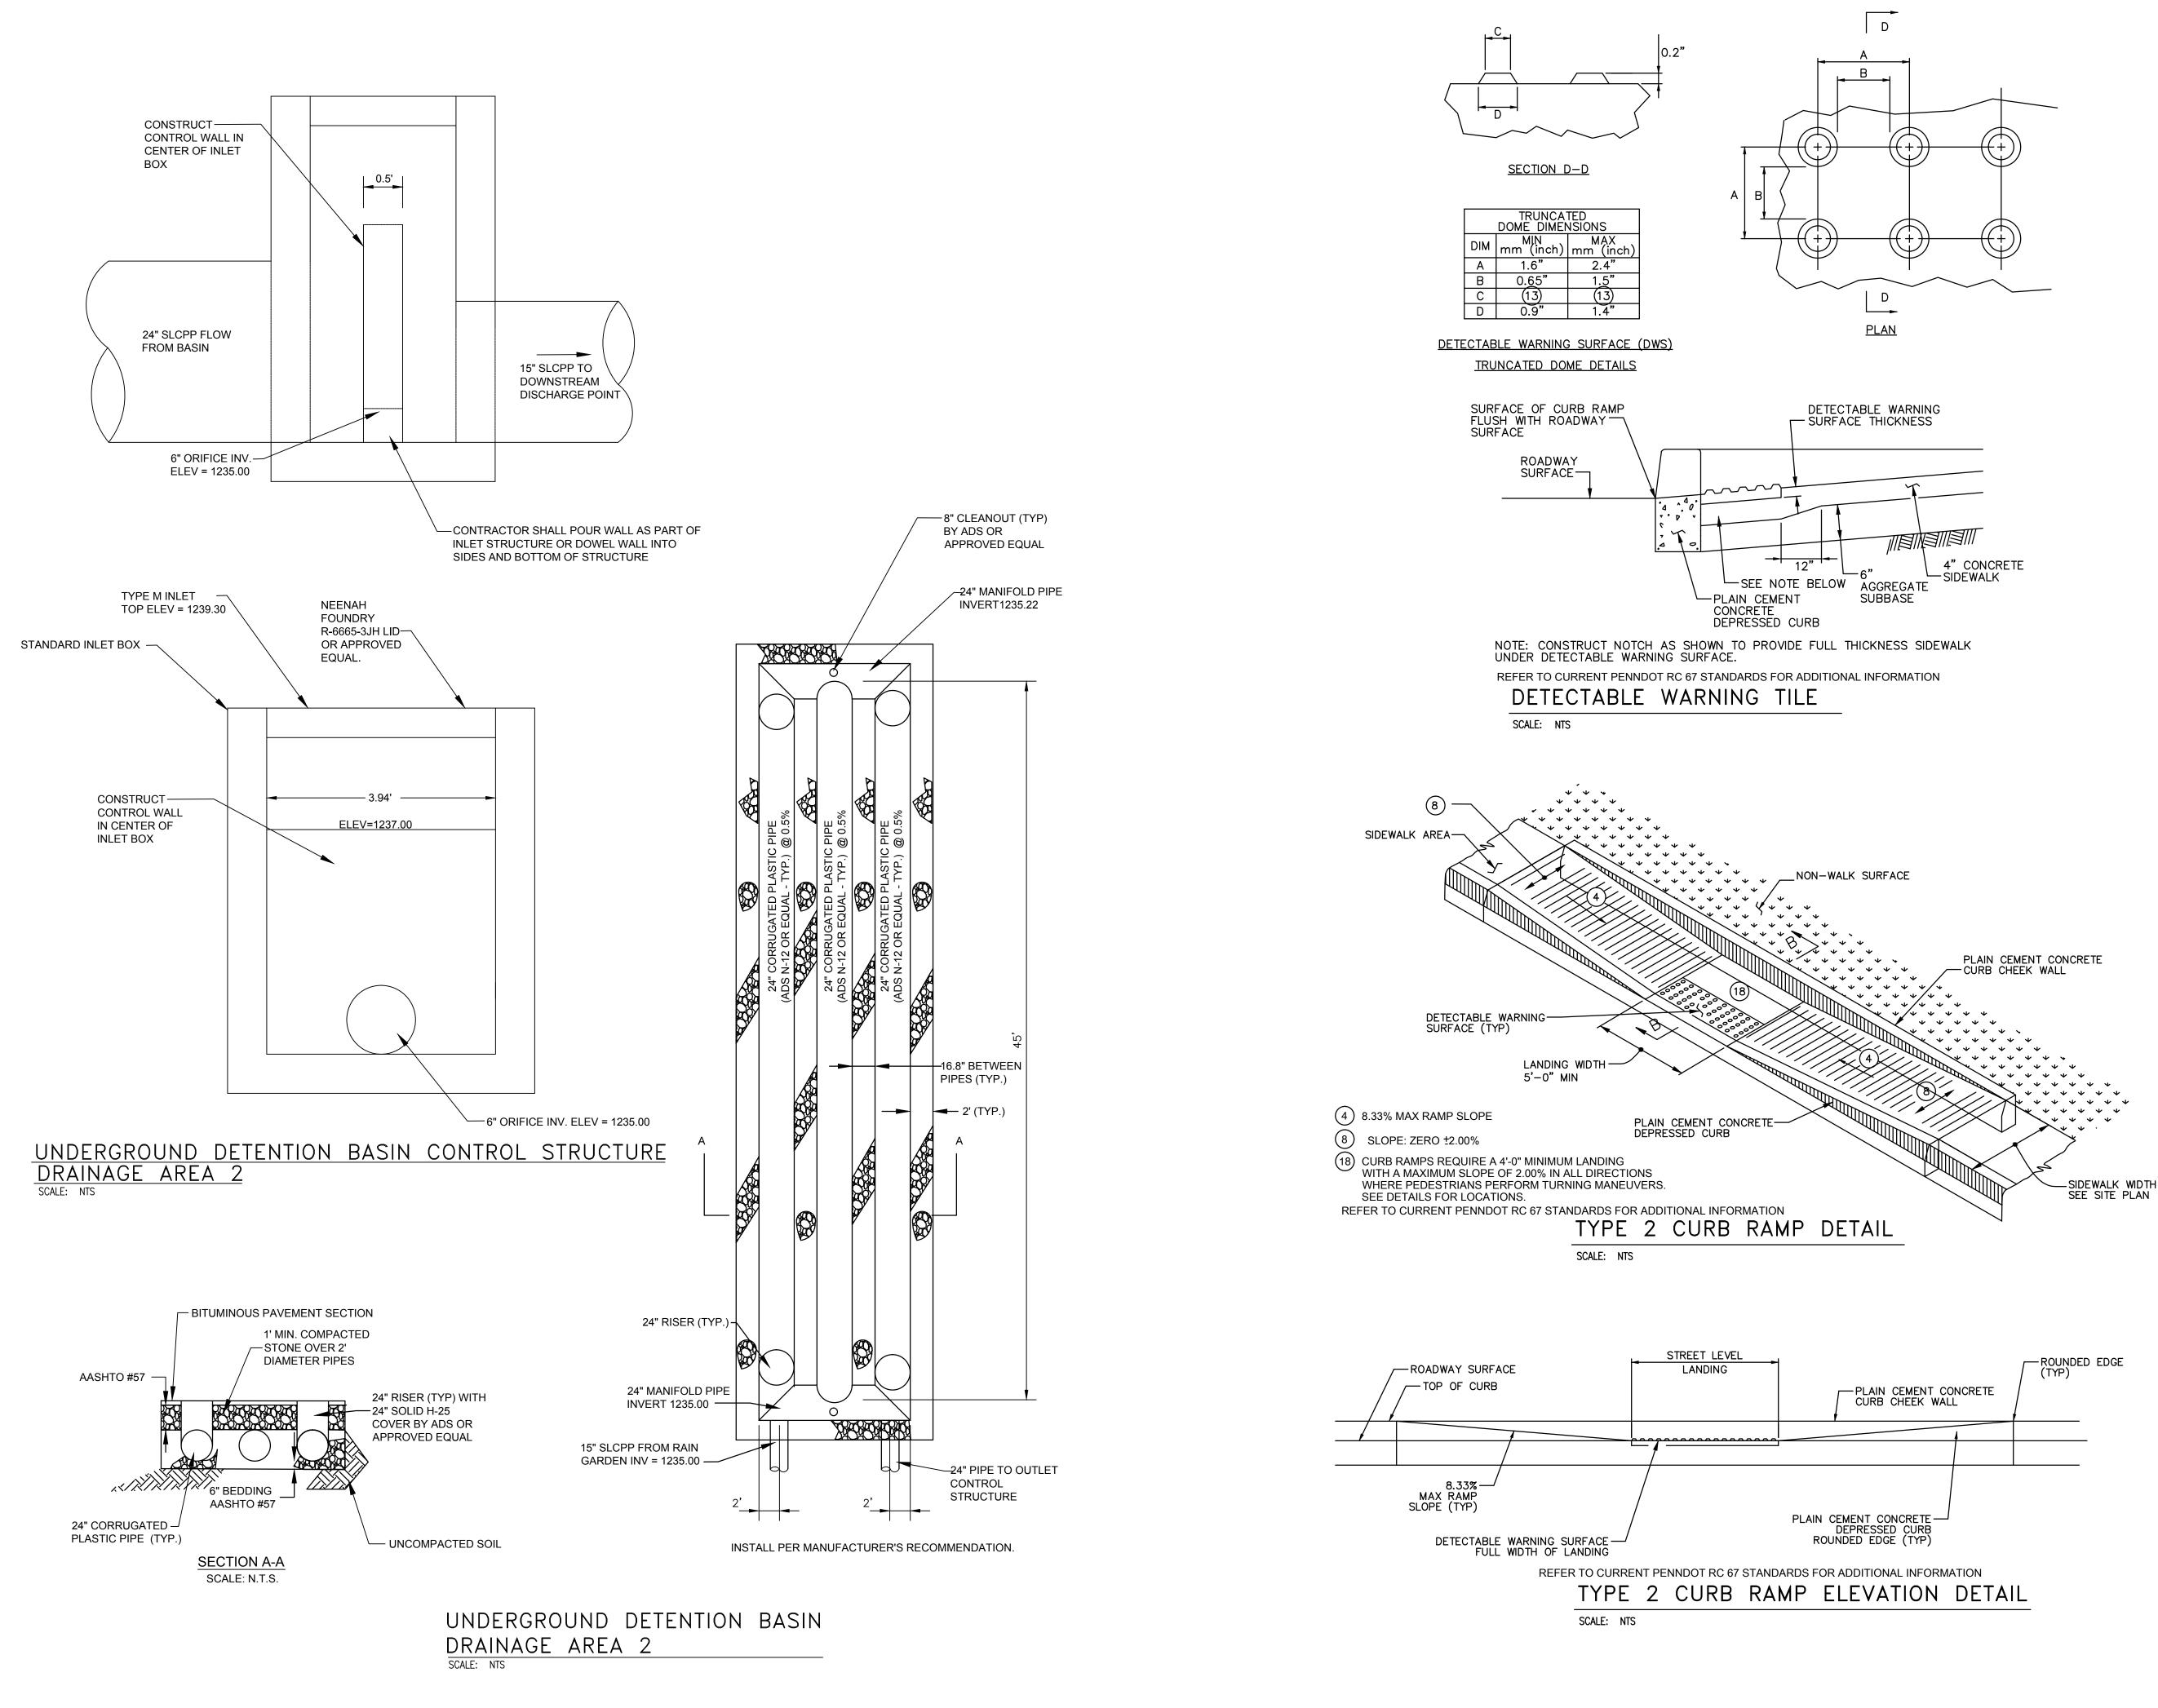
YOUNG SCHOLARS PARKING LOT PROJECT

BALDWIN TOWNSHIP ALLEGHENY COUNTY, PA DEVELOPER:

YOUNG SCHOLARS WESTERN PA CHARTER SCHOOL

600 NEWPORT DRIVE BALDWIN TOWNSHIP, PA 15234

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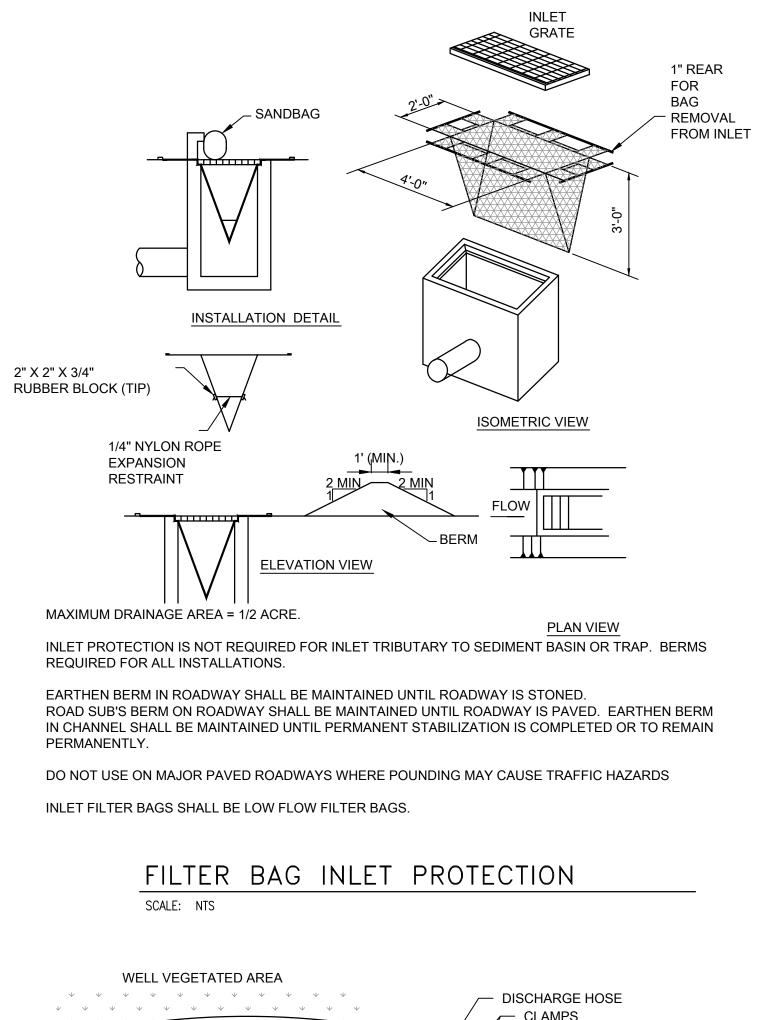
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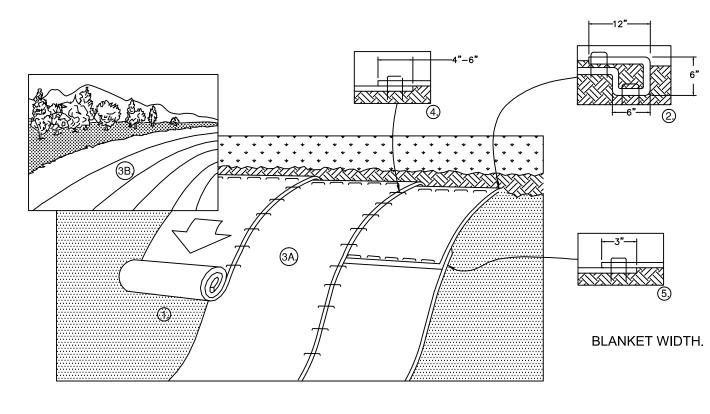
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600 NEWPORT DRIVE BALDWIN TOWNSHIP, PA 15234

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SITE DETAILS				





SCALE: NTS

SEED TYPE TYPE 1 LAWN AREAS PER PENNDOT SPECS) TYPE 2 SLOPED AREAS **GREATER THAN 3:1** PENNDOT FORMULA L TYPE 3 TEMPORARY SEEDING SEE SPECIFICATIONS FOR RAIN GARDEN SEEDING TYPES

MULCHING NOTES QUACKGRASS.

2. WOOD CELLULOSE SHALL BE GREEN DYED AND AIR-DRIED WOOD CELLULOSE FIBERS, CONTAINING NO GROWTH OR GERMINATION INHIBITING SUBSTANCES, IN PACKAGES NOT EXCEEDING ONE HUNDRED POUNDS NET WEIGHT SHOWN ON PACKAGE AND MEETING THE FOLLOWING:

A. MOISTURE CONTENT: 14% +/- 3% B. ORGANIC MATTER (OVEN DRIED BASIS):98.6+/- 0.2% C. ASH CONTENT: 1.4% +/- 0.2% D. WATER HOLDING CAPACITY: 100% MINIMUM


3. SHREDDED BARK SHALL BE SUITABLE FIBROUS GROUND, SHREDDED OR CHUNKS, AGED HARDWOOD BARK, FREE FROM VIABLE, NOXIOUS WEED SEEDS AND INSECT LIFE NOT DECOMPOSED AND BETWEEN 1/4" AND 2" IN DIMENSION


0.75% OF SAPONIFIABLE ACIDS.


B. CUTBACK ASPHALT SHALL CONFORM TO PADOT STANDARDS.

GRASS GROWERS COMPANY OR EQUAL.




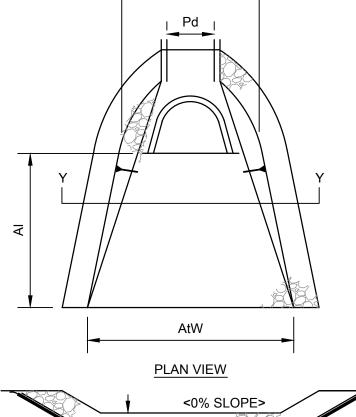

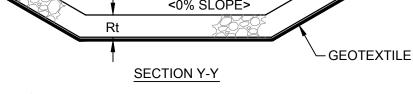

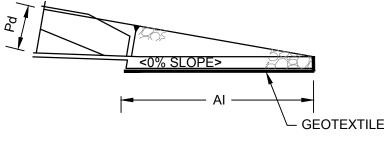

RIPRAP APRONS AT PIPE OUTLETS WITH FLARED END SECTIONS DETAIL

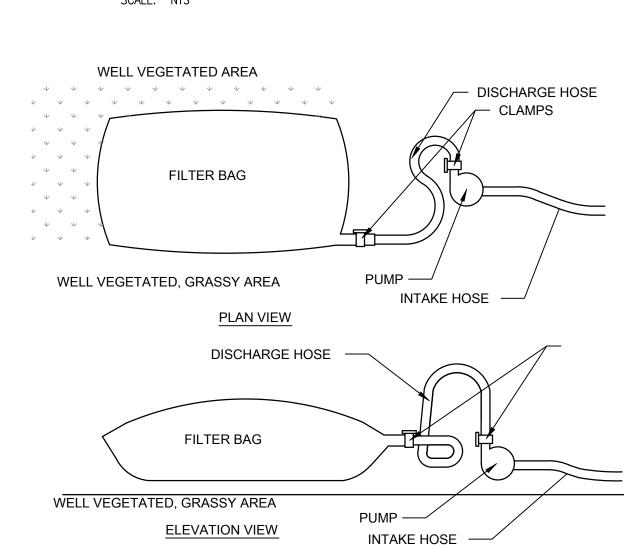

NOTES:

- FILTER BAGS SHALL BE MADE FROM NON-WOVEN GEOTEXTILE MATERIAL SEWN WITH HIGH STRENGTH, DOUBLE STITCHED "J" TYPE SEAMS. THEY SHALL BE CAPABLE OF TRAPPING PARTICLES LARGER THAN 150 MICRONS.
- A SUITABLE MEANS OF ACCESSING THE BAG WITH MACHINERY REQUIRED FOR DISPOSAL PURPOSES MUST BE PROVIDED. FILTER BAGS SHALL BE REPLACED WHEN THEY BECOME 1/2 FULL. SPARE BAGS SHALL BE KEPT AVAILABLE FOR REPLACEMENT OF THOSE THAT HAVE FAILED OR ARE FILLED.
- BAGS SHALL BE LOCATED IN WELL VEGETATED (GRASSY) AREA, AND DISCHARGE ONTO STABLE, EROSION RESISTANT AREAS. WHERE THIS IS NOT POSSIBLE, A GEOTEXTILE FLOW PATH SHALL BE PROVIDED. BAGS SHALL NOT BE PLACED ON SLOPES GREATER THAN 5%.
- THE PUMP DISCHARGE HOSE SHALL BE INSERTED INTO THE BAGS IN THE MANNER SPECIFIED BY THE MANUFACTURER AND SECURELY CLAMPED.
- THE PUMPING RATE SHALL BE NO GREATER THAN 750 GPM OR 1/2 THE MAXIMUM SPECIFIED BY THE MANUFACTURER, WHICHEVER IS LESS. PUMP INTAKES SHOULD BE FLOATING AND SCREENED.

PUMPED WATER FILTER BAG SCALE: NTS

		APRON			
APRON #	PIPE DIA Pd (IN)	LENGTH AI (FT)	INITIAL WIDTH Aiw (FT)	TERMINAL WIDTH Atw (FT)	RIPRAP SIZE (R)
1	15	8	3.75	11.75	R-3
2	15	8	3.75	11.75	R-3

1. PREPARE SOIL BEFORE INSTALLING BLANKETS, INCLUDING ANY NECESSARY APPLICATION OF LIME, FERTILIZER, AND SEED.

2. BEGIN AT THE TOP OF THE SLOPE BY ANCHORING THE BLANKET IN A 6" DEEP X 6" WIDE TRENCH WITH APPROXIMATELY 12" OF BLANKET EXTENDED BEYOND THE UP-SLOPE PORTION OF THE TRENCH. ANCHOR THE BLANKET WITH A ROW OF STAPLES/STAKES APPROXIMATELY 12" APART IN THE BOTTOM OF THE TRENCH. BACKFILL AND COMPACT THE TRENCH AFTER STAPLING. APPLY SEED TO COMPACTED SOIL AND FOLD REMAINING 12" PORTION OF BLANKET BACK OVER SEED AND COMPACTED SOIL. SECURE BLANKET OVER COMPACTED SOIL WITH A ROW OF STAPLES/STAKES SPACED APPROXIMATELY 12" APART ACROSS THE WIDTH OF THE BLANKET.

3. ROLL THE BLANKETS (A.) DOWN OR (B.) HORIZONTALLY ACROSS THE SLOPE. BLANKETS WILL UNROLL WITH APPROPRIATE SIDE AGAINST THE SOIL SURFACE. ALL BLANKETS MUST BE SECURELY FASTENED TO SOIL SURFACE BY PLACING STAPLES/STAKES IN APPROPRIATE LOCATIONS AS PER MANUFACTURERS RECOMMENDATION.

4. THE EDGES OF PARALLEL BLANKETS MUST BE STAPLED WITH MINIMUM 6" OVERLAP. TO ENSURE PROPER SEAM ALIGNMENT, PLACE THE EDGE OF THE OVERLAPPING BLANKET (BLANKET BEING INSTALLED ON TOP) EVEN WITH THE SEAM STITCH ON THE PREVIOUSLY INSTALLED BLANKET.

5. CONSECUTIVE BLANKETS SPLICED DOWN THE SLOPE MUST BE PLACED END OVER END (SHINGLE STYLE) WITH AN APPROXIMATE 3" OVERLAP. STAPLE THROUGH OVERLAPPED AREA, APPROXIMATELY 12" APART ACROSS ENTIRE

6. PLACE STAPLES/STAKES PER MANUFACTURER'S RECOMMENDATION FOR THE APPROPRIATE SLOPE BEING APPLIED. NOTES:

1. IN LOOSE SOIL CONDITIONS, THE USE OF STAPLE OR STAKE LENGTHS GREATER THAN 6" MAY BE NECESSARY TO PROPERLY SECURE THE BLANKETS.

2. FOLLOW EROSION CONTROL TECHNOLOGY COUNCIL SPECIFICATION FOR PRODUCT SELECTION.

EROSION CONTROL BLANKET (SLOPE INSTALLATION)

CALL, NIS									
	SEEDIN	<u>G TABLE</u>							
	% BY	MINIMUM %		MAX %	SEEDING RATE:	FERTILIZER RATE: LBS./1000 S.F.		LIME RATE:	MULCH
	WEIGHT	PURITY	GERMINATION	WEED SEED	LBS./1000 S.F.	BASIC	STARTER	LBS./ RA 1000 S.F.	RATE:
ENNDOT FORMULA B ERENNIAL RYEGRASS IXTURE	20	98	90	0.15	0.44	15-10-10	40	89	3
REEPING RED FESCUE	30	98	85	0.15	0.67				TON/ACRE
ENTUCKY BLUEGRASS	50	98	80	0.20	1.2 TOTAL = 2.3				
HARD FESCUE MIXTURE-A COMBINATION OF IMPROVED CERTIFIED VARIETIES WITH NO DNE VARIETY EXCEEDING 50% OF THE TOTAL HARD FESCUE COMPONENET CREEPING RED FESCUE ANNUAL RYEGRASS	55 35 10	98 98 98	85 85 90	0.15 0.15 0.15	13 8.5 2.5 TOTAL = 24	15-20		100	1 1/2" STRAW 3 TON/ACRE
NNUAL RYEGRASS	100	98	90	0.15	1.1 TOTAL = 1.1	15-20	125		3 TON/ACRE

* STAKES SPACED @ 8' MAXIMUM. USE 2" X 2" (ACTUAL SIZE, NOT NOMINAL) WOOD OR EQUIVALENT STEEL STAKES.

FILTER FABRIC FENCE MUST BE PLACED AT LEVEL EXISTING GRADE. BOTH ENDS OF THE BARRIER MUST BE EXTENDED AT LEAST 8 FEET UP SLOPE AT 45 DEGREES TO THE MAIN BARRIER ALIGNMENT.

THE FENCE.

IMMEDIATELY REPLACED WITH A ROCK FILTER OUTLET

1. STRAW SHALL BE UNROTTED, SMALL, GRAIN FREE OF ALL KINDS OF WEEDS AND PROHIBITIVE NOXIOUS WEEDS SUCH AS: THISTLES, JOHNSONGRASS AND

4. A. EMULSIFIED ASPHALT SHALL CONFORM TO PADOT STANDARDS CONTAINING NO SOLVENTS OR DILUTING AGENTS TOXIC TO PLANT LIFE AND NOT MORE THAN

C. NON ASPHALTIC EMULSION SHALL BE NATURAL VEGETABLE GUM BLENDED WITH JELLING AND HARDENING AGENTS (TERRA TACK AR) AS MANUFACTURED BY

D. OTHER MULCH BINDERS AS APPROVED BY THE PADEP BUREAU OF LAND AND WATER CONSERVATION.

SEEDING TABLE AND MULCHING NOTES

SCALE: NTS


EROSION AND SEDIMENTATION NOTES

UNTIL THE SITE IS STABILIZED, ALL EROSION AND SEDIMENTATION CONTROLS MUST BE MAINTAINED PROPERLY. MAINTENANCE MUST INCLUDE INSPECTIONS OF ALL EROSION AND SEDIMENTATION CONTROLS AFTER EACH STORM EVENT AND ON A WEEKLY BASIS. ALL PREVENTATIVE AND REMEDIAL MAINTENANCE WORK, INCLUDING CLEAN OUT, REPAIR, REPLACEMENT, REMULCHING, AND RENETTING MUST BE PERFORMED IMMEDIATELY.

SHOULD ANY MEASURE CONTAINED WITHIN THIS PLAN PROVE INCAPABLE OF ADEQUATELY REMOVING SEDIMENT FROM ON-SITE FLOWS PRIOR TO DISCHARGE OR OF STABILIZING THE SURFACES INVOLVED, ADDITIONAL MEASURES MUST BE IMMEDIATELY IMPLEMENTED BY THE PROPERTY OWNER TO ELIMINATE ALL SUCH PROBLEMS.

AFTER FINAL SITE STABILIZATION HAS BEEN ACHIEVED, TEMPORARY EROSION AND SEDIMENTATION CONTROLS MUST BE REMOVED. AREAS DISTURBED DURING REMOVAL OF THE CONTROLS MUST BE STABILIZED.

PER SOIL MAPPING, THE ONLY SOIL LOCATED WITHIN THE LIMIT OF DISTURBANCE IS URBAN LAND-GUERNSEY COMPLEX (UGD). THIS URBAN SOIL IS UNCLASSIFIED AND HAS NO CHARACTERISTICS DOCUMENTED.

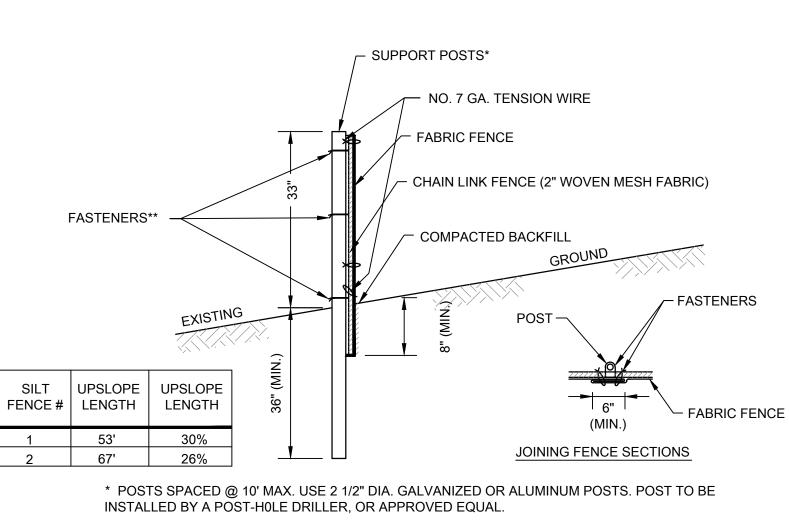

** CHAIN LINK TO POST FASTENERS SPACED @ 14" MAX. USE NO. 6 GA. ALUMINUM WIRE OR NO. 9 GALVANIZED STEEL PRE-FORMED CLIPS. CHAIN LINK TO TENSION WIRE FASTENERS SPACED @ 60" MAX. USE NO. 10 GA. GALVANIZED STEEL WIRE. FABRIC TO CHAIN FASTENERS SPACED @ 24" MAX. C TO C.


NO. 7 GA. TENSION WIRE INSTALLED HORIZONTALLY AT TOP AND BOTTOM OF CHAIN-LINK FENCE.


FILTER FABRIC FENCE MUST BE PLACED AT EXISTING LEVEL GRADE. BOTH ENDS OF THE BARRIER MUST BE EXTENDED AT LEAST 8 FEET UPSLOPE AT 45 DEGREES TO THE MAIN BARRIER ALIGNMENT.

SEDIMENT MUST BE REMOVED WHEN ACCUMULATIONS REACH 1/2 THE ABOVE GROUND HEIGHT OF THE FENCE.





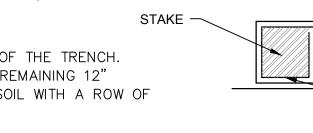

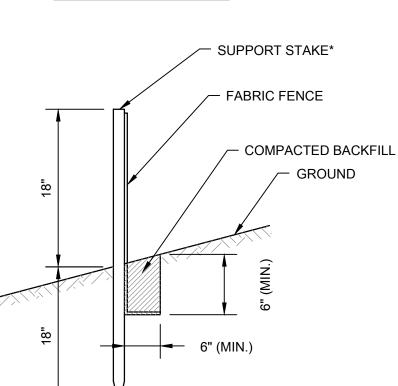

JOINING FENCE SECTIONS

STAPLES

SEDIMENT MUST BE REMOVED WHEN ACCUMULATIONS REACH 1/2 THE ABOVE GROUND HEIGHT OF

ANY SECTION OF FILTER FABRIC FENCE WHICH HAS BEEN UNDERMINED OR TOPPED MUST BE

SILT FENCE #	UPSLOPE LENGTH	UPSLOPE LENGTH
3	33'	15%
4	35'	13%
5	35'	11%
6	22'	18%
7	25'	18%
8	21'	20%

STANDARD FILTER FABRIC FENCE (18" HIGH)

SCALE: NTS





A CDI Company

615 West Highland Ave. Ebensburg, Pa. 15931 (814) 472-7700 phone (814) 472-7712 fax web site www.lrkimball.com

CONSULTANTS:

PROJECT NAME:

YOUNG SCHOLARS PARKING LOT PROJECT

BALDWIN TOWNSHIP ALLEGHENY COUNTY, PA DEVELOPER:

YOUNG SCHOLARS WESTERN PA CHARTER SCHOOL

600 NEWPORT DRIVE BALDWIN TOWNSHIP, PA 15234

1	3/11/14	CONSTRUCTION DOCUMENTS			
REV.	DATE	DESCRIPTION			
ISSUE	:	1/16/2014			
	ECT NO:	13-2200-0236			
SCAL		AS NOTED			
	/N BY: KED BY:	MAK GLS			
		ture, LLC dba L.R. Kimball			
CUEL	T TITLE				
SITEE					
(EROSION AND SEDIMENTATION CONTROL DETAILS				

LAND DEVELOPMENT PLAN FOR THE YOUNG SCHOLARS PARKING LOT PROJECT ALLEGHENY COUNTY, PENNSYLVANIA BALDWIN TOWNSHIP

SHEET INDEX

CS000	COVER SHEET
C000	EXISTING CONDITIONS PLAN
C100	SITE DEMOLITION PLAN
C110	SITE PLAN
C120	SITE GRADING PLAN
C130	SITE UTILITY PLAN
C140	EROSION AND SEDIMENTATION CONTROL PLAN
C510	SITE DETAILS
C511	SITE DETAILS
C512	SITE DETAILS
C513	SITE DETAILS
C550	EROSION AND SEDIMENTATION CONTROL DETAILS



UTILITIES

MUNICIPAL: BALDWIN TOWNSHIP 10 COMMUNITY PARK DRIVE PITTSBURGH, PA 15234 CONTACT: ROB ZAHORCHAK PHONE: 412-341-9597

WATER: PENNSYLVANIA AMERICAN WATER COMPANY 560 HORNING ROAD BETHEL PARK, PA 15102 CONTACT: JOE TEWELL EMAIL: joseph.tewell@amwater.com


GAS: COLUMBIA GAS OF PA 251 WEST MAIDEN STREET WASHINGTON, PA 15301 CONTACT: SHANNON GRIEST EMAIL: sgriest@nisource.com

TELEPHONE: VERIZON PENNSYLVANIA LLC 15 E MONTGOMERY AVE. PITTSBURGH, PA 15212

CABLE TV: COMCAST 5211 BROWNSVILLE ROAD PITTSBURGH, PA 15236

ELECTRIC: DUQUESNE LIGHT COMPANY 2645 NEW BEAVER AVE. PITTSBURGH, PA 15233 CONTACT: BRYAN CLARK EMAIL:bclark@duqlight.com

SITE LOCATION

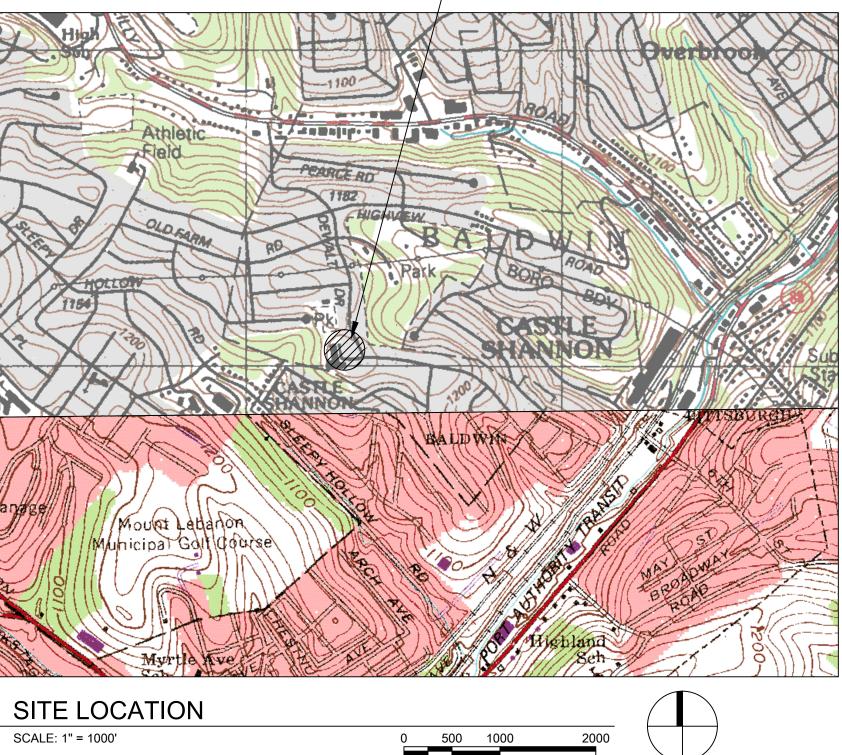



Know what's **below**. Call before you dig.



STOP - CALL US BEFORE YOU DIG PENNSYLVANIA ONE CALL SYSTEMS, INC. 3 BUSINESS DAYS NOTICE IS THE LAW! 8-1-1 OR 1-800-242-1776 www.paonecall.org

General Utility & One Call Information:

The location of underground utilities are shown in an approximate way only and have not been independently verified by the Using Agency. The Contractor shall determine the exact location of all existing utilities before commencing work, and agrees to be fully responsible for any and all damages which may occur by the Contractor's failure to exactly locate and preserve any and all utilities.

Contractor shall notify the PA One Call System not less than three (3) days prior to construction. The Contractor shall place the call and provide an approximate date and time that digging will occur. The One Call System will then notify the public and private utilities in the area. Public and private utilities will then coordinate directly with the Contractor for actual field locations.

PA One Call System Phone: 8-1-1 OR 1-800-242-1776 POCS Serial Number: 20132902513-000

ZONING - R-1 USE: PUBLIC OR PRIVATE SCHOOL CONDITIONAL USE NEEDED SURROUNDING PROPERTY IS R-1

EXISTING USE - PRIVATE SCHOOL PROPOSED USE - PRIVATE SCHOOL MAX BUILDING AREA - 22%

SETBACKS:

FRONT YARD - 35' SIDE YARD - 5' MIN AGGREGATE 15' REAR YARD – 30' PARKING:

LAND OWNER: NEWPORT DRIVE PROPERTIES 600 NEWPORT DRIVE BALDWIN TOWNSHIP, PA 15234

DEVELOPER: YOUNG SCHOLARS WESTERN PA CHARTER SCHOOL 600 NEWPORT DRIVE BALDWIN TOWNSHIP, PA 15234



ACTUAL – 13.8%

TOTAL EXISTING SPACES - 39 SPACES TOTAL PROPOSED SPACES - 75 SPACES

THE SURVEY WAS PREPARED BY L.R. KIMBALL ON OCTOBER 23RD AND NOVEMBER 19TH, 2013.



A CDI Company

615 West Highland Ave Ebensburg, Pa. 15931 (814) 472-7700 (814) 472-7712 www.lrkimball.com web site

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YOUNG SCHOLARS PARKING LOT PROJECT

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1	2/11/11	
	3/11/14	CONSTRUCTION DOCUMENTS DESCRIPTION
REV.	DATE	
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SCALE:		AS NOTED
DRAWN B		MAK GLS
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SHEET TI	TLE	

COVER SHEET

CS000